### **Project Summary**

This project summary is intended to provide a general understanding of the work and is not intended to be all inclusive. These drawings depict the exterior restoration of the historic Union School Building (circa 1895). The building is the located in the Dunstable Historic District. The building is currently unoccupied. However, it is attached to the actively used Swallow Elementary School which is part of the Groton-Dunstable Regional School District.

The scope of work for the Dunstable Union Building Exterior Restoration includes, but is not limited to, the following:

- Siding repair and replacement
- 2. Wood trim and molding repairs and replacement
- Flashing repairs and replacement
- Paint removal and new painting
- 5. Window and door replacement
- 6. Chimney and foundation masonry repointing
- Slate roof repairs
- Replace existing exterior light fixtures with new LED fixtures
- 9. Replace asphalt roofs with 16 oz flat seam copper

### Alternate #1

• Replace all exterior wood siding and exterior wood trim at Connector portion of building

### **Building Aerial View**



**Locus Plan** 

- Area of Work



### Dunstable Union Building Exterior Restoration

522 Main Street, Dunstable, MA 01827

3/12/2025

Bid Set

### **DRAWING LIST**

### General Project Information

Title Sheet

**General Notes** 

Contractor Site Access Plan

Contractor Site Access Plan Enlarged

G-5 **Existing Photos** 

**Existing Photos** 

Demolition

Site Demolition Plan **Roof Demolition Plan** 

AD131 AD132

North, East, and West Roof Areas of Damage South Roof Areas of Damage AD133

North Elevation Demolition AD200 North Elevation Front Entry Demolition

AD210 West Elevation Demolition

AD220 South Elevation Demolition

AD230 **East Elevation Demolition** AD500 Egress Stair Door & Window Infill Details

Demolition

Architectural

A131

**Roof Plan Proposed** 

A200 North Elevation Proposed

A201 North Elevation Front Entry Proposed A210 **West Elevation Proposed** 

A220 South Elevation Proposed

**East Elevation Proposed** A230

Egress Stair Door & Window Infill Details A500

A501 **Proposed Details & Schedules** 

**OWNER/CLIENT** 

Dunstable, MA 01827

511 Main St

(978) 649-4514

Town of Dunstable

Begin Here. Finish Well.

**ARCHITECT** 

20 Conant Street

gienapparchitects.com Danvers, MA 01923

**HAZARDOUS MATERIALS CONSULTANT** 

**Environmental & Construction** Management Services Inc.

288 Grove Street #391 Braintree, MA 02184 617-338-2121

**G-1** 

Bid D

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Abbrev	Abbreviations							
ADJ	Adjustable	FAP	Fibrous Acoustical Panels	LOW	Limit of Work	RNS	Rubber Nailing Strip	
AFF	Above Finish Floor	FCP	Fabric Covered Acoustic Panel	LP	Low Point	RO	Rough Opening	
ALT	Alternate	FD	Floor Drain	LSG	Linoleum Sheet Goods	RSB	Resilient Straight Base	
ALUM	Aluminum	FDVC	Fire Department Valve Connection	LVP	Luxury Vinyl Plank	RTU	Rooftop Unit	
ACOUST	Acoustic/Acoustical	FE	Fire Extinguisher	1.4.A.D.		RT	Rubber Tile	
AP	Access Panel	FF	Finish Floor	MAR	Marble	RUB	Rubber Flooring	
ASB	Asbestos	FFIN FH	Factory Finish	MAX	Maximum Marker Board	RVL	Reveal	
ATC ATHL	Acoustical Tile Ceiling Athletic	FHC	Fume Hood Fire Hose Cabinet	MB MECH	Mechanical	SAFB	Sound Attenuation Fire	
AVB	Air and Vapor Barrier	FIN	Finish	MFR	Manufacturer	SCUP	Scupper	
AVD	All alla vapor barrier	FIB WD	Fibrous Wood	MH	Manhole	SD	Soap Dispenser	
BLDG	Building	FLR	Floor	MIN	Minimum	SECT	Section	
BLK	Block	FLHD	Flat Head	MR	Mirror	SF	Square Foot	
ВМ	Bench Mark	FLHD MS	Flat Head Machine Screw	MSC	Miscellaneuous	SFCMU	Split face CMU	
ВО	Bottom of	FND	Foundation	МО	Masonry Opening	SFTU	Structural Facing Tile U	
BR	Backer Rod	FO	Face of	MS	Machine Screw	SGFT	Structural Glazed Face	
BR+S	Backer Rod and Sealant	FOF	Face of Foundation	MS	Mop Sink	SHT	Sheet	
BRK	Brick	FOM	Face of Masonry	MT	Marble Tile	SIM	Similar	
BSMT	Basement	FOS	Face of Stud	MTL	Metal	SK	Sink/Lavatory	
		FOW	Face of Window	MTD	Mounted	SP	Station Point	
C	Course(s)	FP	Fire Protection			SPEC	Specification	
CB	Catch Basin	FR	Fire Rated	NAT	Natural Finish	SRB	Straight Resilient Base	
CBB	Cementatious Backerboard	FRP	Fiberglass Reinforced Glass Panel	ND NCMB	Feminine Napkin Dispenser	SS	Stainless Steel	
CH CHT	Coat Hook	FTR	Finned Tube Radiator	NGMB NIC	Non-Glare Marker Board Not in Contract	SSF STC	Synthetic Sports Flooring Sound Transmission Cl	
CHI	Changing Table Control Joint	FURN FWP	Furnish/Furnished Fibrous Wood Panel	NO	Number	STD	Standard/Stud	
CL	Center Line	FVVF	ribious wood Parier	NRC	Noise Reduction Coefficent	STL	Steel	
CLSRM	Classroom	GA	Gauge	NTS	Not to Scale	STLP	Steel Linear Panel	
CLG	Ceiling	GALV	Galvanized	1113	Not to Scale	STR	Stair	
CLR	Clear	GB	Grab Bar	OC	On center	STRUCT	Structure(al)	
CM	Construction Manager	GC	General Contractor	OD	Outside Diameter	SUSP	Suspended	
CMP	Composite Metal Panel	GFCMU	Ground Face CMU	OHD	Overhead Door	SYS	System	
CMU	Concrete Masonry Unit	GFI/GFCI	Ground Fault Circuit Interrupter	OHFD	Overhead Folding Door	SCI	Science	
COL	Column	GFRG	Glass Fiber Reinforced Gypsum	OHRD	Overhead Rolling Door			
COMP	Compressable	GL	Glass	OHRG	Overhead Rolling Grille	T	Tread	
CONC	Concrete	GLCMU	Glazed Face CMU	OPG	Opening	Т	Tempered	
CONT	Continuous	GYP	Gypsum	OPP	Opposite	TB	Tackboard	
CPT	Carpet	GWB	Gypsum Wall Board	ORD	Overflow Drain	TDF	Transparent Dye Finish	
CR	Card Reader	GWB/AR	GWB; Abuse Resistant	DI 444	DI VI I I I	TERR	Terrazzo	
CRD	Cementitous Roof Deck	GWF	Glazed Wall Finish	PLAM	Plastic Laminate	T&G	Tongue and Groove	
CT CTB	Ceramic Tile	Н	Liah	PCF	Pre-molded Compressible Filler	TI TO	Tapered Insulation	
CU FT	Ceramic Tile Base Cubic Foot	н HD	High Hand Dryer	PFC PL	Preformed Cladding Plate	TOP	Top of Top of Partition	
CUH	Cabinet Unit Heater	HDW	Hardware	PLAS	Plaster	TP	Toilet Paper Dispenser	
CUYP	Cubic Yard	HDWD	Hardwood	PLYWD	Plywood	TS	Strucutral Tube Steel	
CVR	Cover	HM	Hollow Metal	PM	Pressed Metal	TYP	Typical	
CW	Curtain Wall	HORZ	Horizontal	PNL	Panel		. )	
		HP	High Point/Handicapped	PORC	Porcelain Tile	UCD	<b>Undercut Door</b>	
DEMO	Demolition	HPC	High Performance Coating	PR	Pair	UON	<b>Unless Otherwsie Note</b>	
DF	Drinking Fountain	HR	Hour	PREFAB	Prefabricated	USS	<b>Underside of Structure</b>	
DIM	Dimension	HVC	Hose Valve Cabinet	PREFIN	Prefinished	UTIL	Utility/ Utilities	
DN	Down			PSF	Pounds per Square Foot	UV	Unit Ventilator	
DO	Door Opening	IBC	International Building Code	PSI	Pounds per Square Inch	UR	Urinal	
DR(s)	Door(s)	IECC	International Energy Conservation	PT	Pressure Treated	1/65	March 1.0	
DS	Down Spout	10	Code	PT	Paper Towel Dispenser	VCB	Vented Cove Base	
DTL DWG(s)	Detail Drawing(s)	ID INCL	Inside Diameter Include	PTD PTN	Painted Partition	VCP VCT	Vitreous Clay Pipe	
DWG(s)	Drawing(s)	INST	Install/Installed	PVC	Polyvinyl Chloride	VERT	Vinyl Composite Tile Vertical	
EA	Each	INSUL	Insulation	PTT	Precast Terrazzo Tile	VENT	Verify in Field	
EJ	Expansion Joint	INT	Interior	7 1 1	riecast remazzo me	VSF	Vinyl Sheet Flooring	
EL	Elevation Height	INV	Invert	QT	Quarry Tile	VTR	Vent Through Roof	
ELEC	Electric/Electrical	<del>-</del>		~ .		VWC	Vinyl Wall Covering	
ELEV	Elevator	J	Jamb	R	Riser	-	,	
EMERG	Emergency	JT	Joint	RAD	Radius	W	Wide	
EOD	Edge of Deck			RCB	Resilient Cove Base	w/, w/o	With/Without	
EOS	Edge of Slab	KD	Knock Down	RCP	Reflected Ceiling Plan	WB	Wood Base	
EQ	Equal	KO	Knock Out	RD	Roof Drain	WC	Water Closet	
EQUIP	Equipment	KIT	Kitchen	REINF	Reinforced	WD	Wood	
ETBR	Existing to be Removed	KP	Kickplate	REQD	Required	WMP	Wire Mesh Partition	
ETR	Existing to Remain			RES	Resinous Flooring	WO	Window Opening	
EXIST	Existing	L	Low	RHMS	Round Head Metal Screw	WP	Working Point	
EXP	Exposed	LCC	Lead Coated Copper	RM	Room	WR	Waste Receptacle	
EXT	Exterior	LGMF	Light Gauge Metal Framing			WWF	Welded Wire Fabric	
1		LCT	Linoleum Composite Tile			WWM	Welded Wire Mesh	

### Symbol Legend Wall Section Tag **Building Section Tag** ire Batt **Enlarged Detail Tag** A101 Unit e Tile **Elevation Tag** Level Tag Elevation Column Grid Tag 〔1i 〕 Partition Type Tag [10A] Window Tag **Revision Tag** Path of Travel Tag Length 100AA) ← Door Tag Ceiling Type A 10' 5-5/8" A.F.F. Ceiling Height

Room name ← Room Name

- Room Number

Project North

True North

**Project North** 

101

Project

North

### **General Notes**

### **Project Information**

- A. All work shall conform with all applicable Codes and ordinances and with accepted local standards of the trades.
- B. Only the highest quality of workmanship shall be considered acceptable and shall be firmly secured and relative to elevations and dimensions as shown in the drawings true to plumb, level, square,
- The Contractor shall report any and all discrepancies or omissions found in the Drawings and Specifications to the Architect. The Work affected shall not proceed until clarification is issued or permission to continue is provided.
- D. Items noted "Not In Contract", "N.I.C.", "By [Separate] Vendor", "By [Separate] Contractor", or "By Owner" are to be neither furnished nor installed under this Contract unless noted otherwise, but are shown for informational purposes only. It is the responsibility of the Contractor to coordinate with separate vendors and contractors to complete the work of this project.
- The Contractor shall be responsible for coordinating all aspects of the Work and shall inform the Owner of their work schedule and any anticipated changes that may occur in it.
- The Contractor shall place orders for all materials included in the Work by General Contractor or Subcontractor (where applicable) in time to prevent any delays in the construction schedule or completion of the Work unless noted otherwise.
- G. The Contractor shall not proceed with any work which they believe to be contrary to their knowledge of good construction standards and practices and shall not use any sub-standard materials.
- H. The Contractor shall be expected to inspect the site for conditions affecting work and for anticipating the effects of those conditions
- upon their work. Minor details not usually shown or specified, but necessary for the proper installation or conformance with Codes or standards listed herein, shall be included in the Work.
- The Contract Documents represent the finished structure and do not indicate the methods of construction unless specifically noted otherwise. The Contractor shall supervise and direct the Work and shall be solely responsible for construction means, methods, techniques, sequences, and procedures.
- K. Each trade shall coordinate its work as is practical and will interfere as little as possible with the work of other trades and persons. It will be assumed that each trade has accepted the quality of the work of others upon which his work must be applied.

### <u>Dimensions, Measurements, and Layout</u>

- A. Dimensions shall take precedence over graphic representations. Scaling of the drawings for dimensions or locations of materials or equipment is considered unacceptable.
- B. Larger scale drawings take precedence over smaller scale drawings.
- C. Notes and details on Drawings shall take precedence over these General Notes and Typical Details. Written Specifications take precedence over graphic representation of materials and items as well as their locations.
- D. All dimensions are to finish materials unless noted otherwise.
- Dimensions to side or center of doors or windows are to finish
- openings unless noted otherwise. . The Contractor shall be responsible for locating and laying out the Work (including elevations). The Contractor shall exercise proper precaution to verify figures shown on the Drawings while laying out the Work, and be responsible for all errors resulting from failure to exercise such precaution.



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Description


Project: 825.1 Drawn by: EA Check by: MN Date: 3/12/25 Scale: As indicated

**General Notes** 

### **General Demolition Notes**

### **Demolition General Notes**

- A. The owner shall remove all non-fixed salvage items prior to demolition. Contractor shall coordinate with owner prior to demolition regarding fixed items to be turned over to the owner as
- B. Protect all existing building components which are to remain. Repair any damaged areas as required to return them to their original condition.
- C. Provide temporary protection and weather tight enclosure where exterior enclosure items (doors, walls, windows, roofing, skylights) have been removed.
- D. Contractor to notify Architect and Owner if materials containing hazardous materials are encountered.
- E. Conform to applicable regulatory procedures when discovering hazardous or contaminated materials.
- F. Conform to applicable code for demolition of structures, safety of adjacent structures, dust control, and disposal of materials.
- G. Notify affected utility companies before starting work, and comply with their requirements.
- H. Demolish existing work in an orderly and careful manner as required to accommodate new work. Prevent movement or settlement of structure. Provide bracing and/or shoring as required to maintain safety.
- Coordinate all demolition work with owner as necessary.
- Contractor to provide and install all temporary means of egress, temporary lighting, and safety devices in accordance with state and local codes.
- K. Contractor is responsible for maintaining the fire rating and integrity of existing walls and ceilings.
- L. All fireproofing at structural elements shall remain UNO. Any fireproofing removed and/or damaged during the course of demolition and subsequent construction shall be replaced with the same materials and rating as that which was removed at the Contractor's expense.
- M. Demolition Contractor shall coordinate all mechanical, electrical, and plumbing demolition work with plans prior to the commencement of any work and coordinate his work with the General
- Contractor and other sub-contractors as necessary. N. All mechanical, electrical, and plumbing fixtures, equipments and/or devices scheduled to be removed shall be disconnected at the source, unless noted or directed otherwise. Coordinate all
- work with mechanical, electrical, and plumbing plans.
- O. Contractor to coordinate the removal, disconnection, and/or capping of any utilities with owner as necessary.
- P. Electrical Contractor shall disconnect and remove all (E) electrical and telephone outlets and all associated wires in walls scheduled to be removed and terminated at the last outlet that remains
- Q. All empty or abandoned conduit and junction boxes to be removed back to its source.
- R. Removal and capping of plumbing fixtures to be coordinated per plan and with General Contractor to maintain required minimum usage during construction (when applicable).

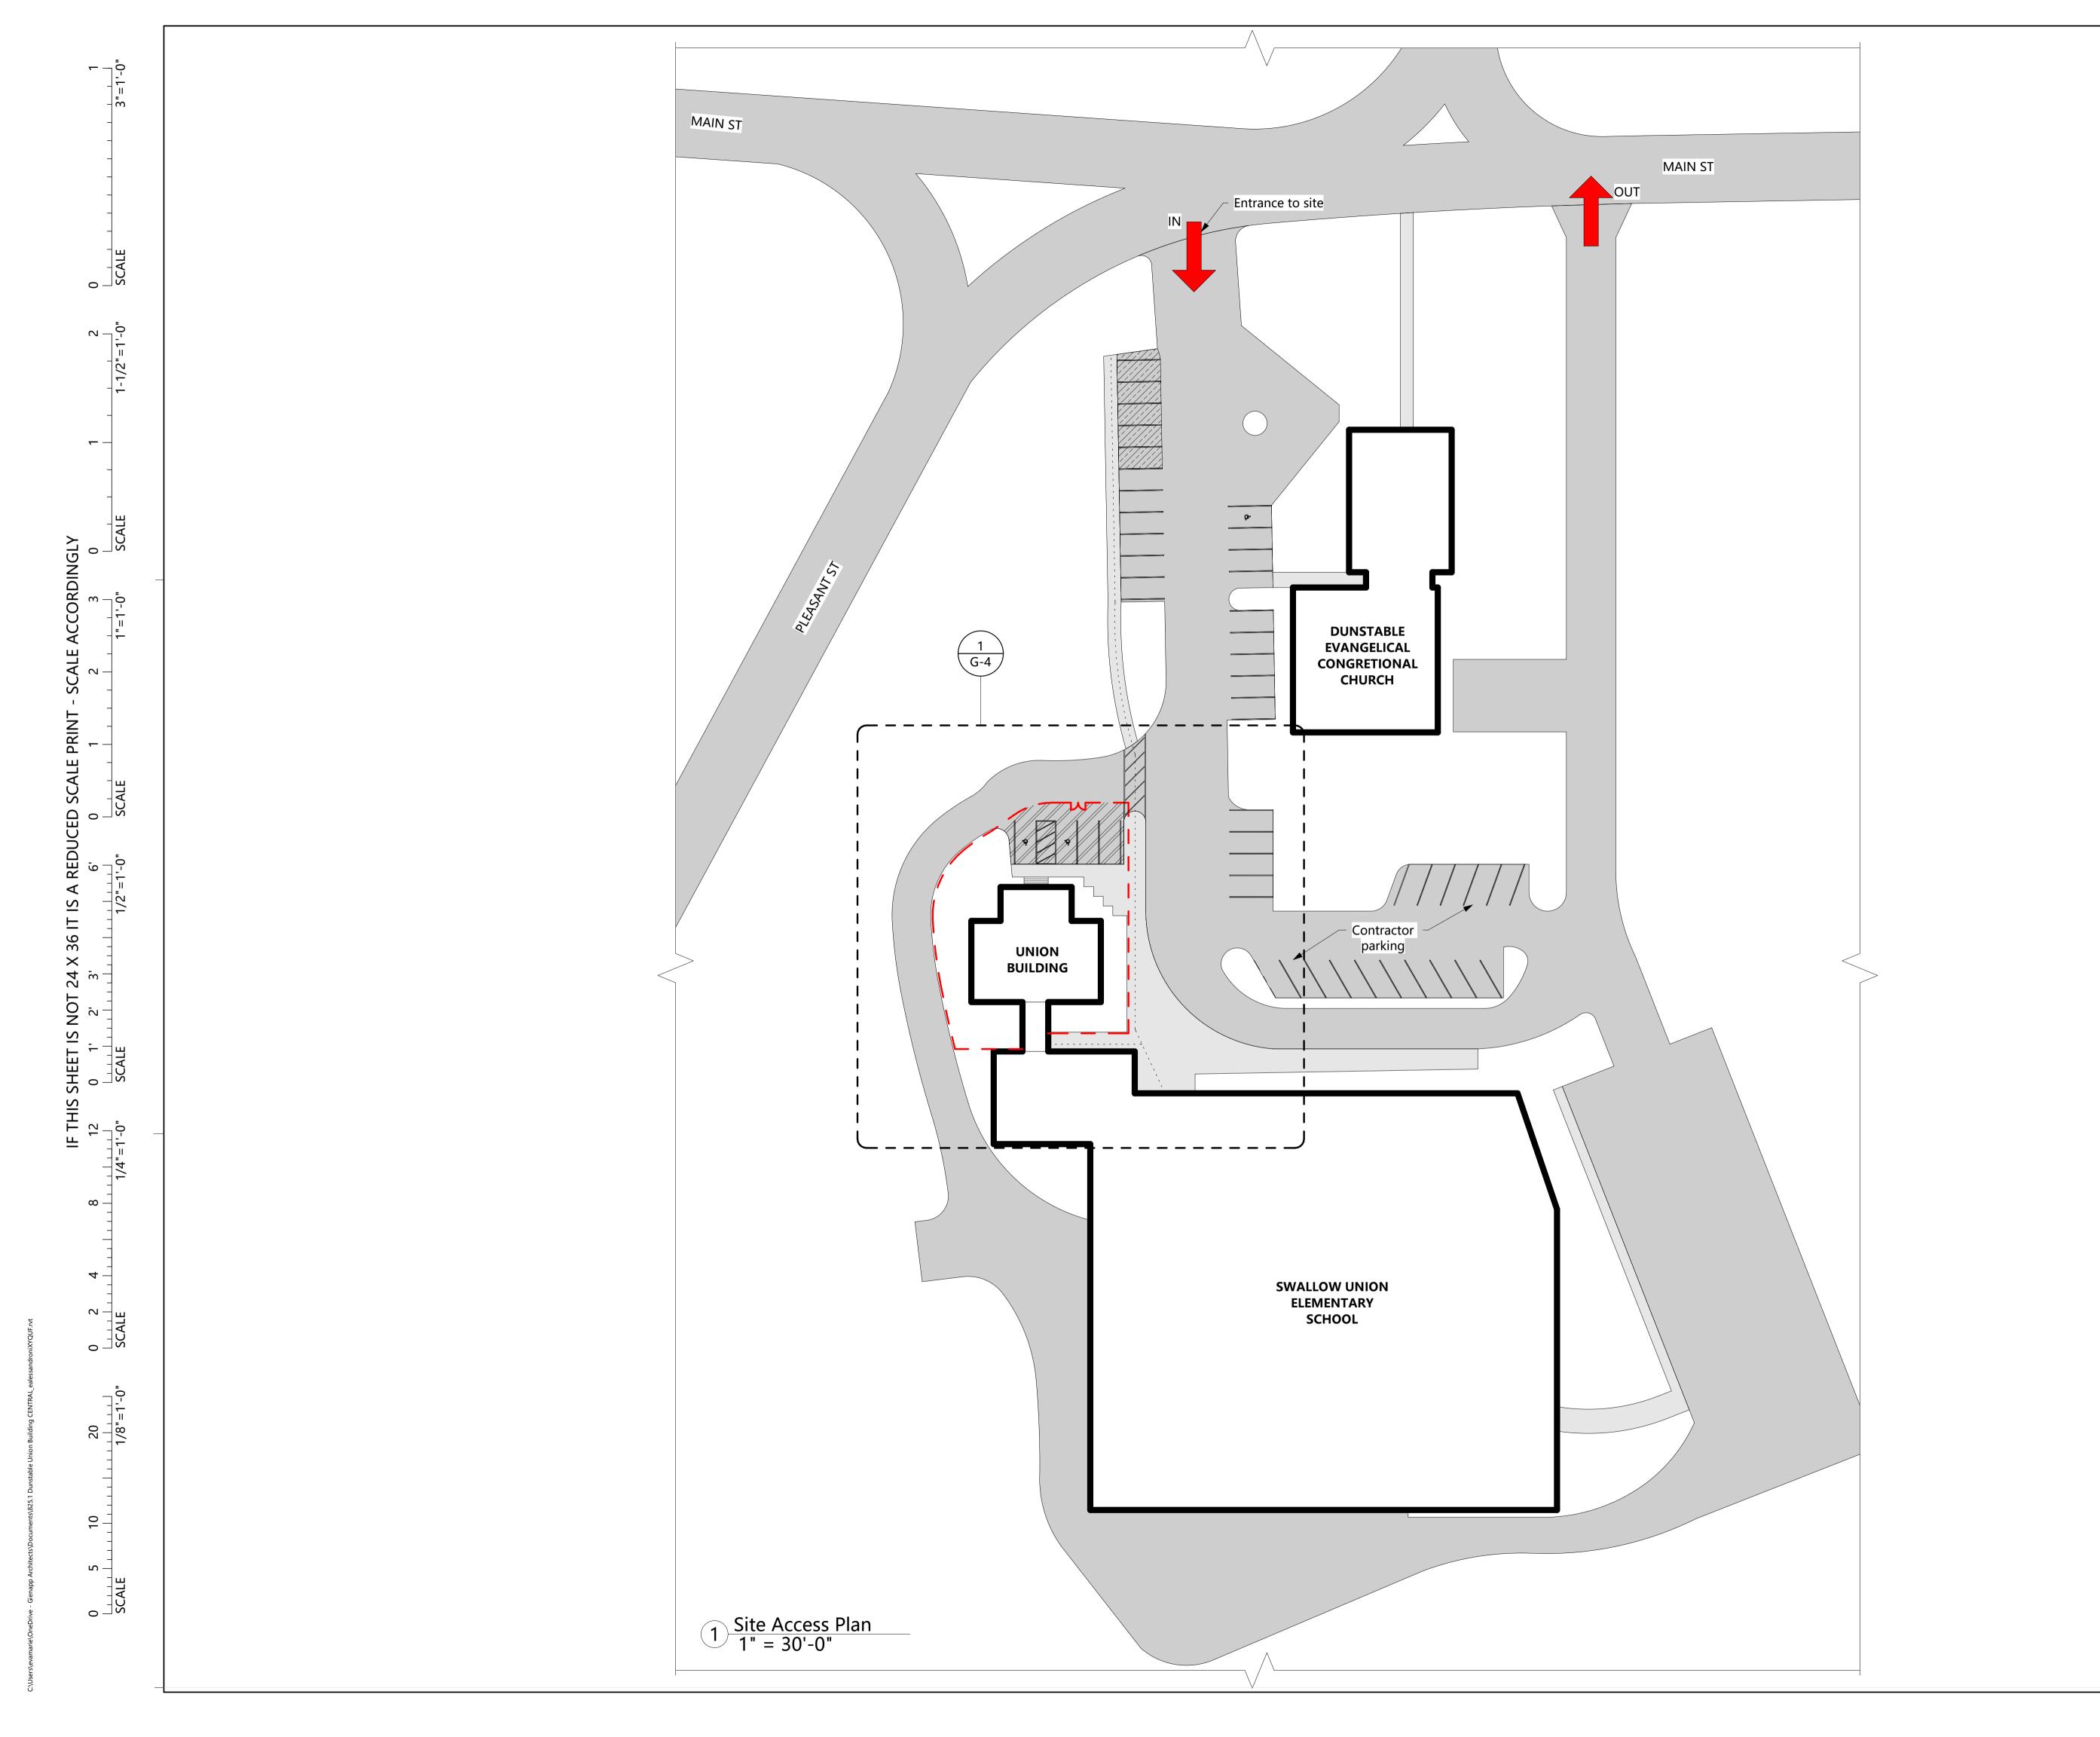

Legend

Contractor access, parking, & storage

Maintain pedestrian path

Existing vehicular roadway

Existing pedestrian walkway

Contractor parking

Contractor laydown area

Existing tree

Existing shrub

Note: Refer to spec section 01 5000 (typ.) GIENAPP ARCHITECTS Begin Here. Finish Well.

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## unstable Union Building Exterior Restoration Bid Set

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Dunstable,

Street,

Main

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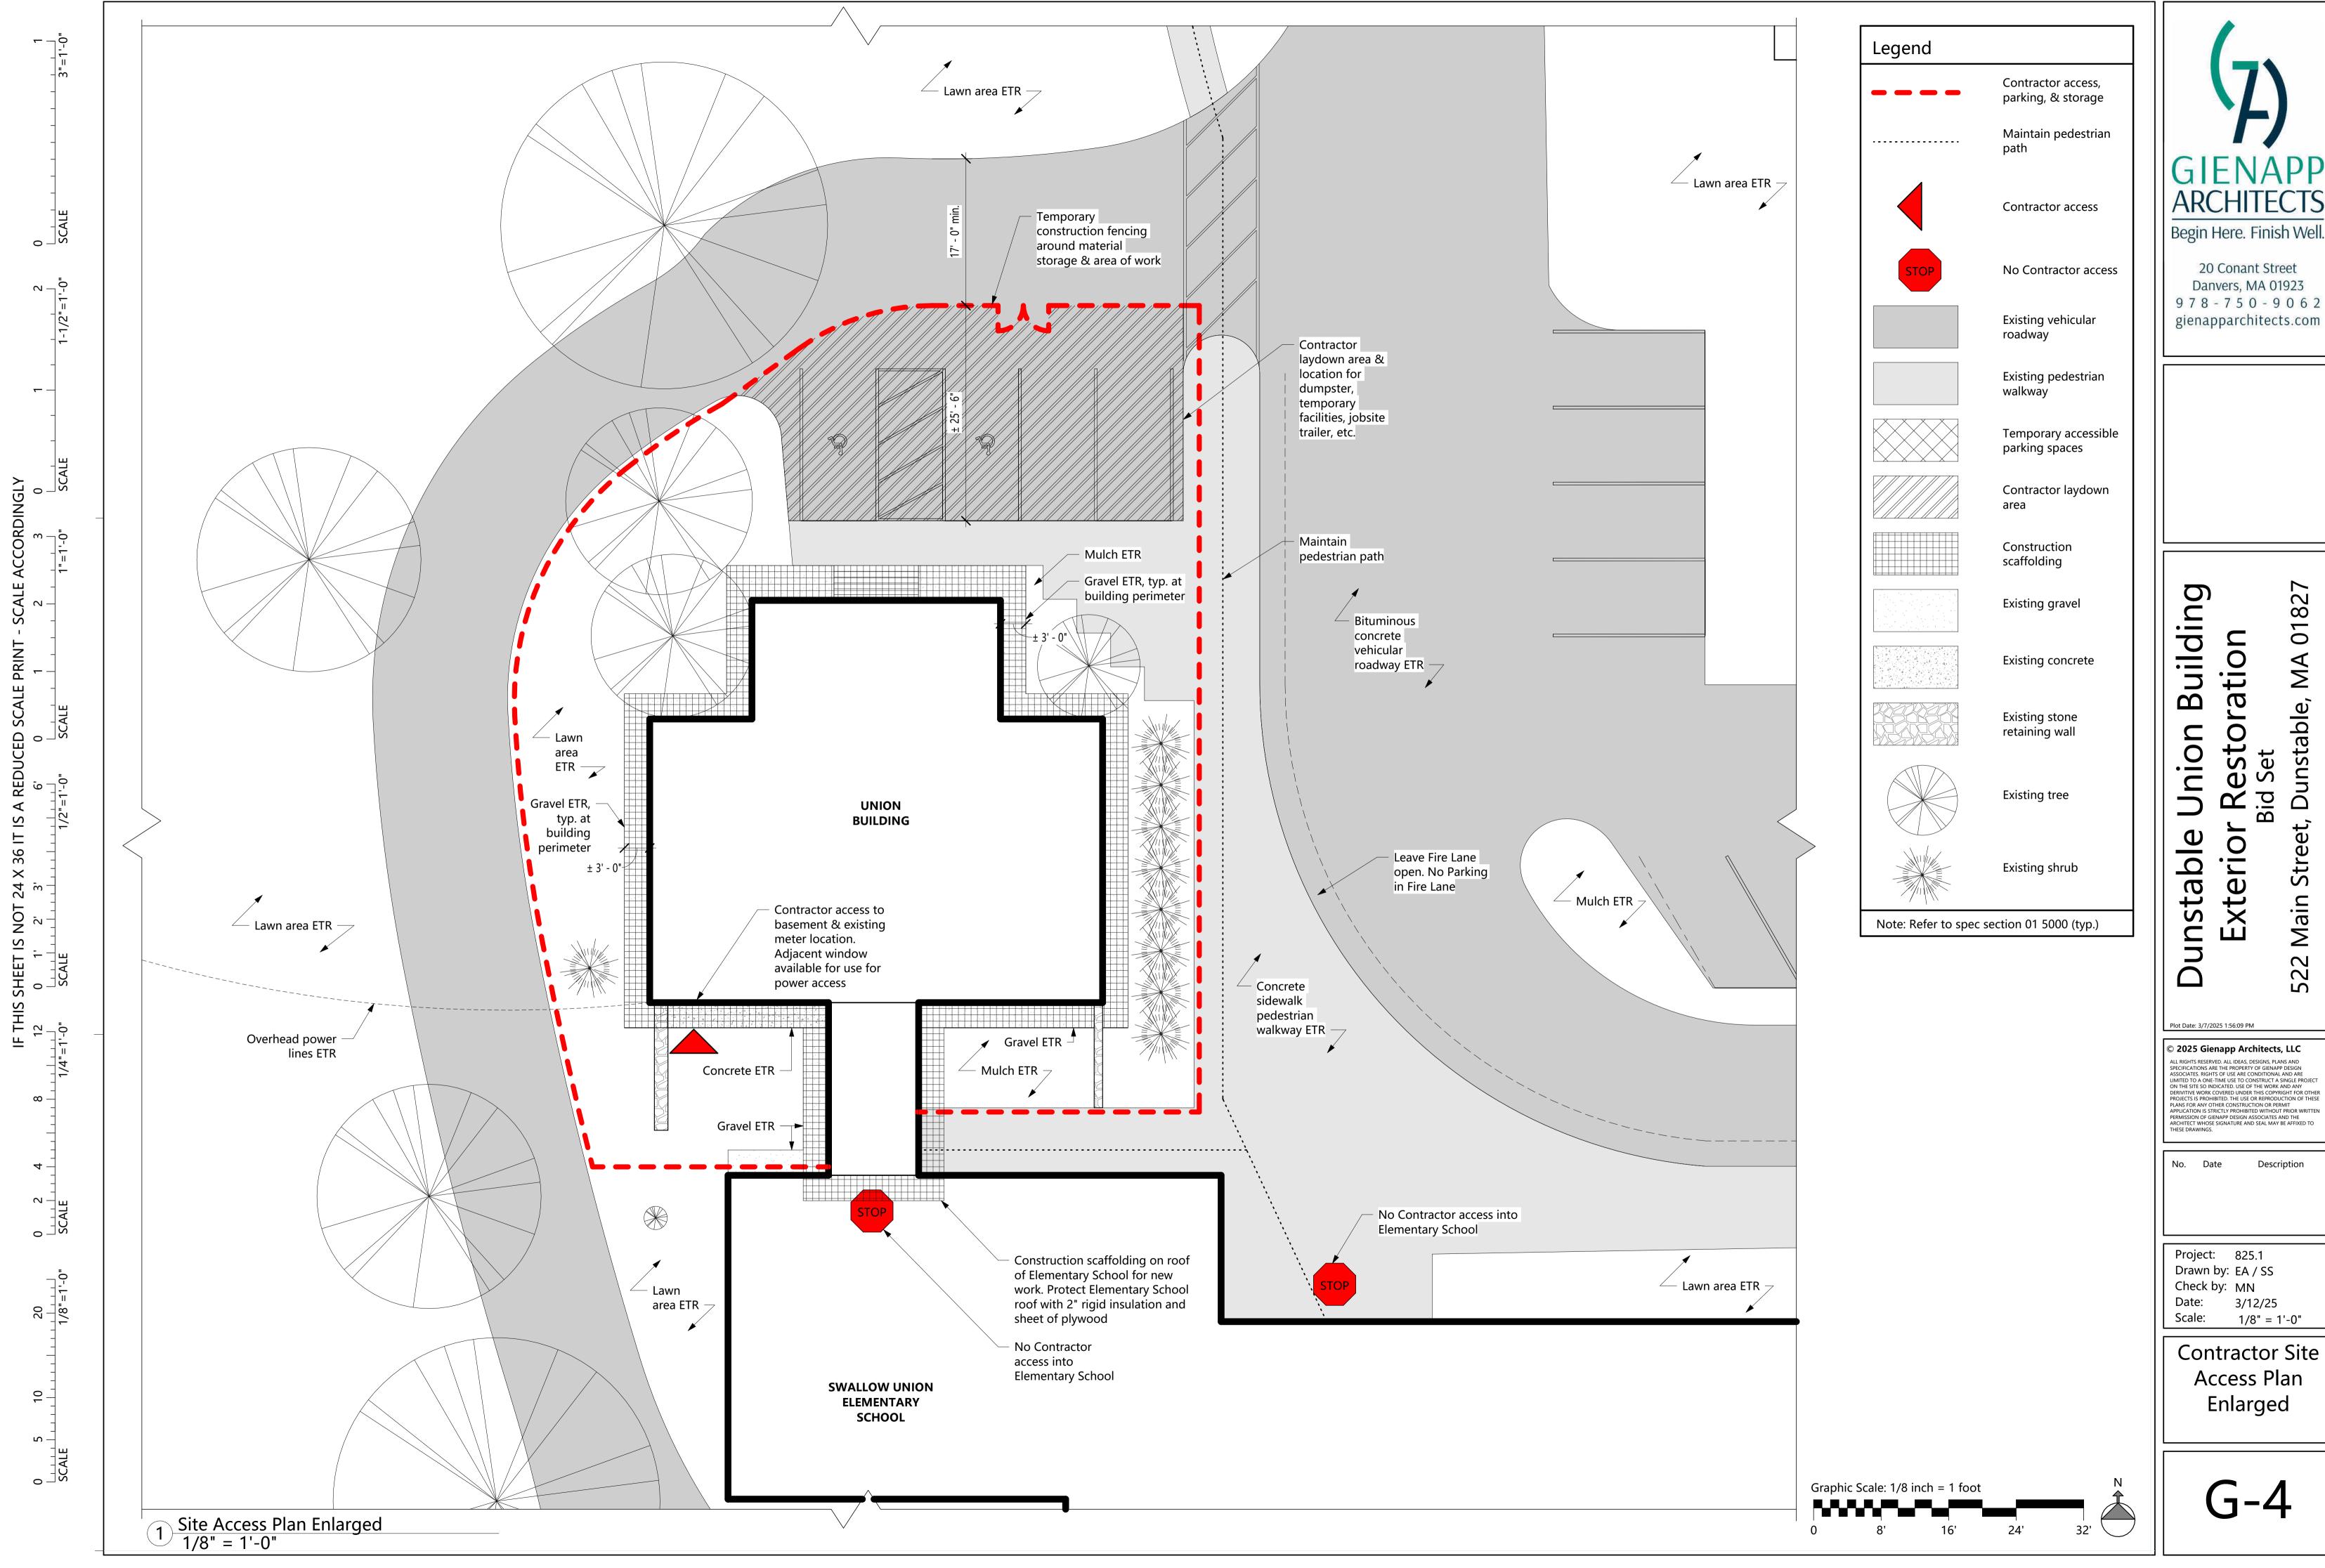
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Contractor Site Access Plan

G-3



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Description

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**Contractor Site** Access Plan Enlarged










3 Palladian Window

4 Rake Return

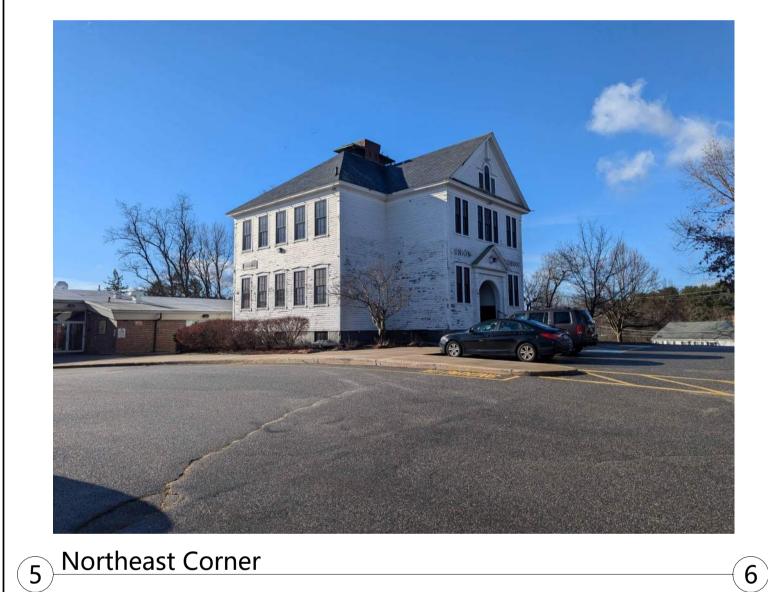








6 Southwest Corner

7 Southeast Corner

8 Northwest Corner





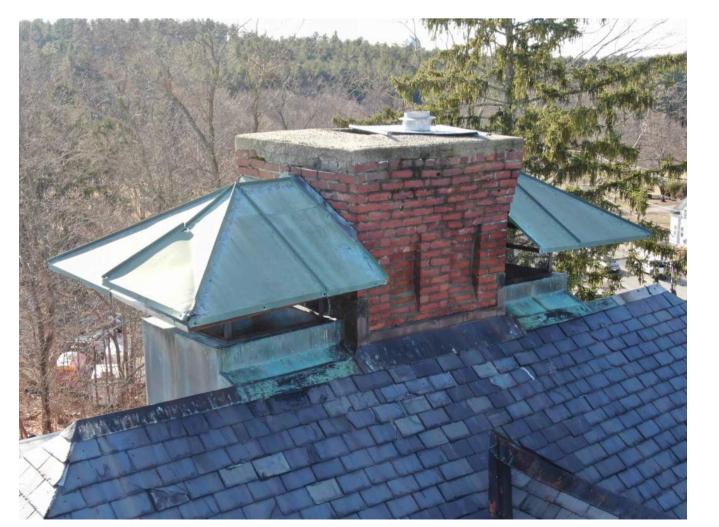



Mechanical Vent Hood



# Building Exterior unstable

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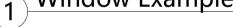
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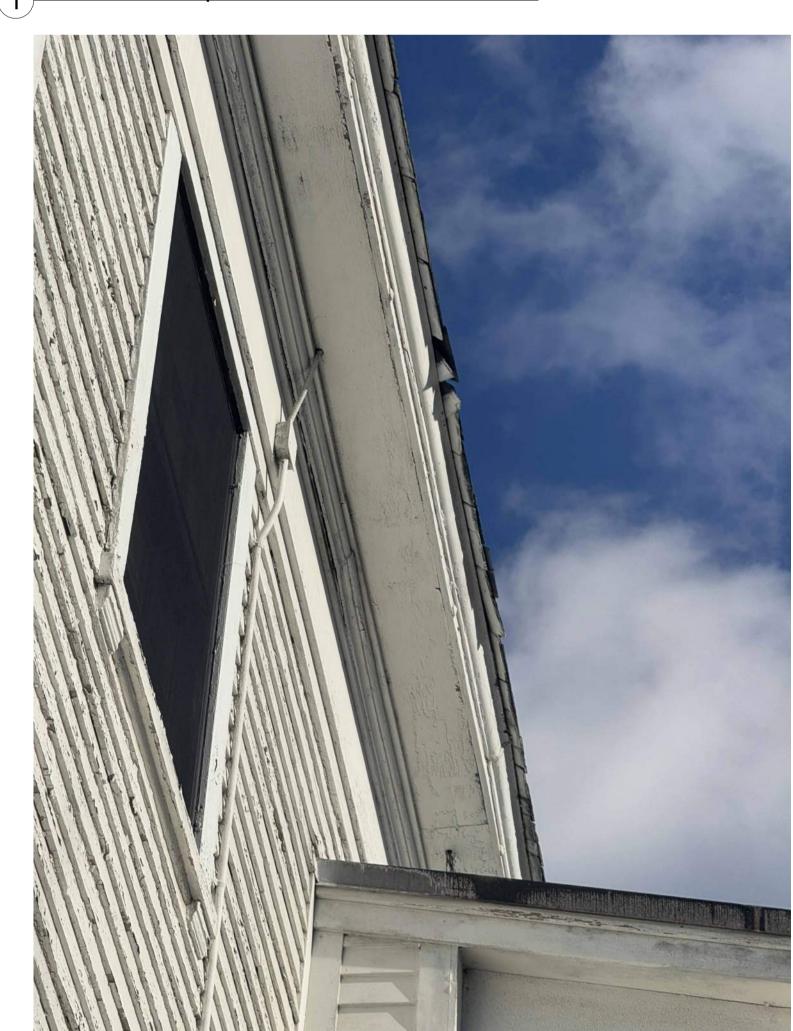
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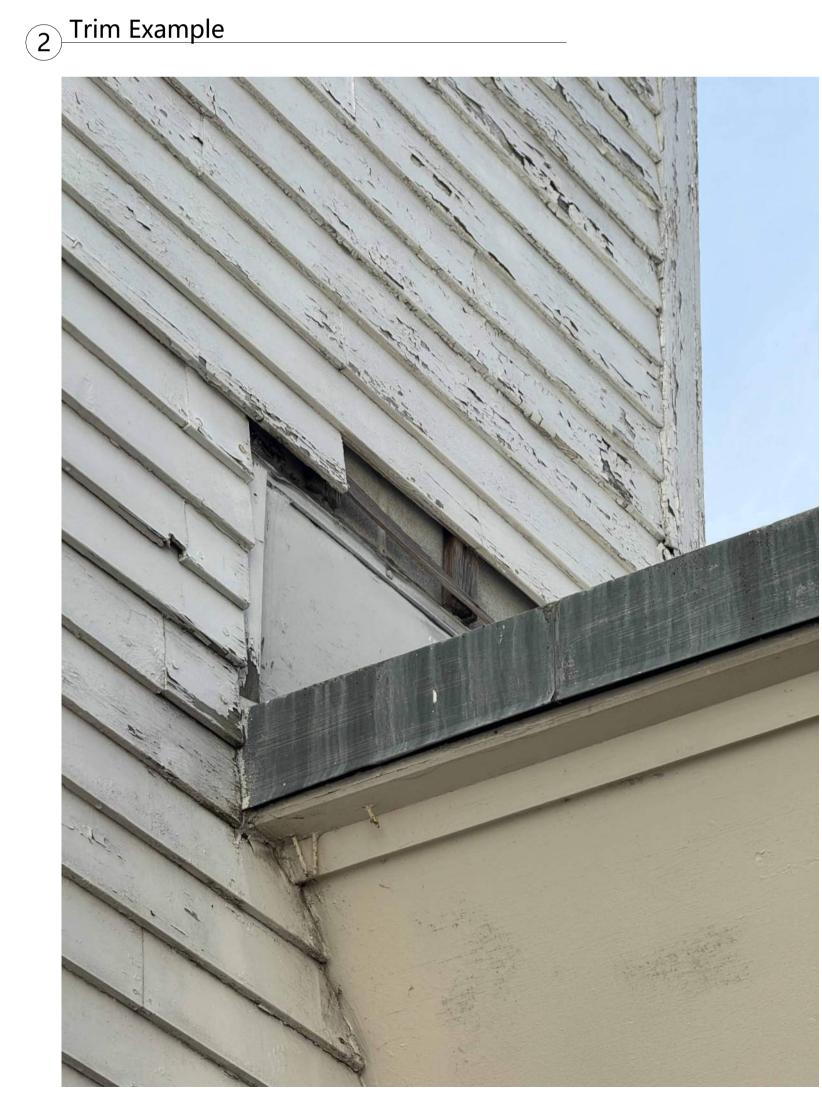
**Existing Photos** 

G-5




4 Soffit Example






5 Siding Detail Example

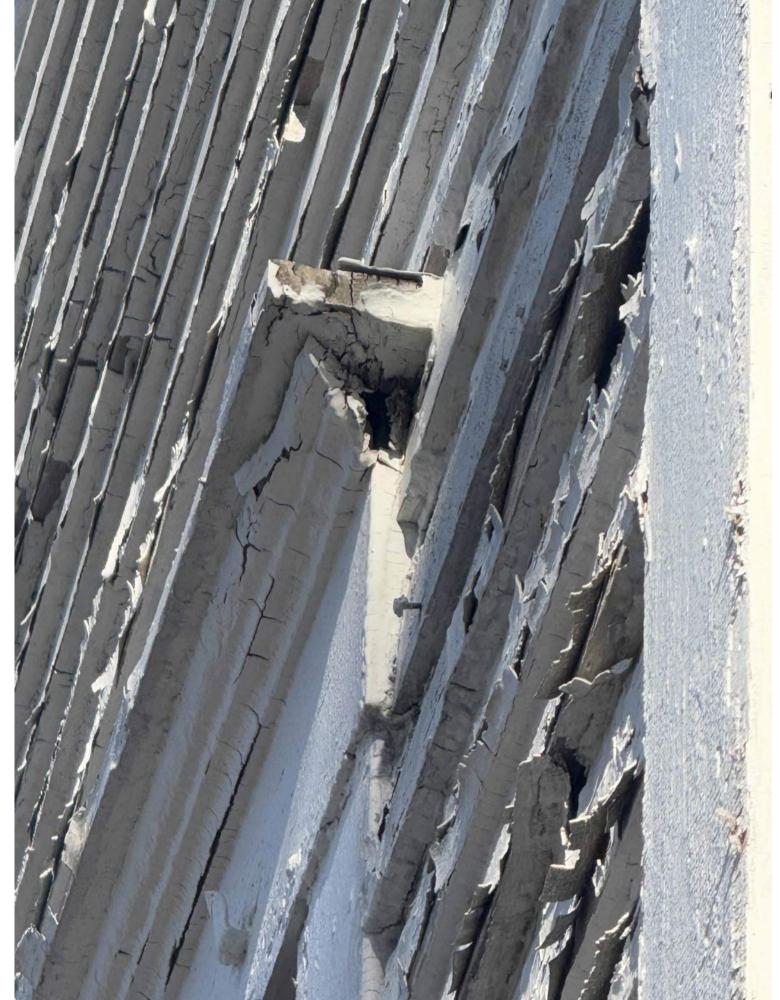





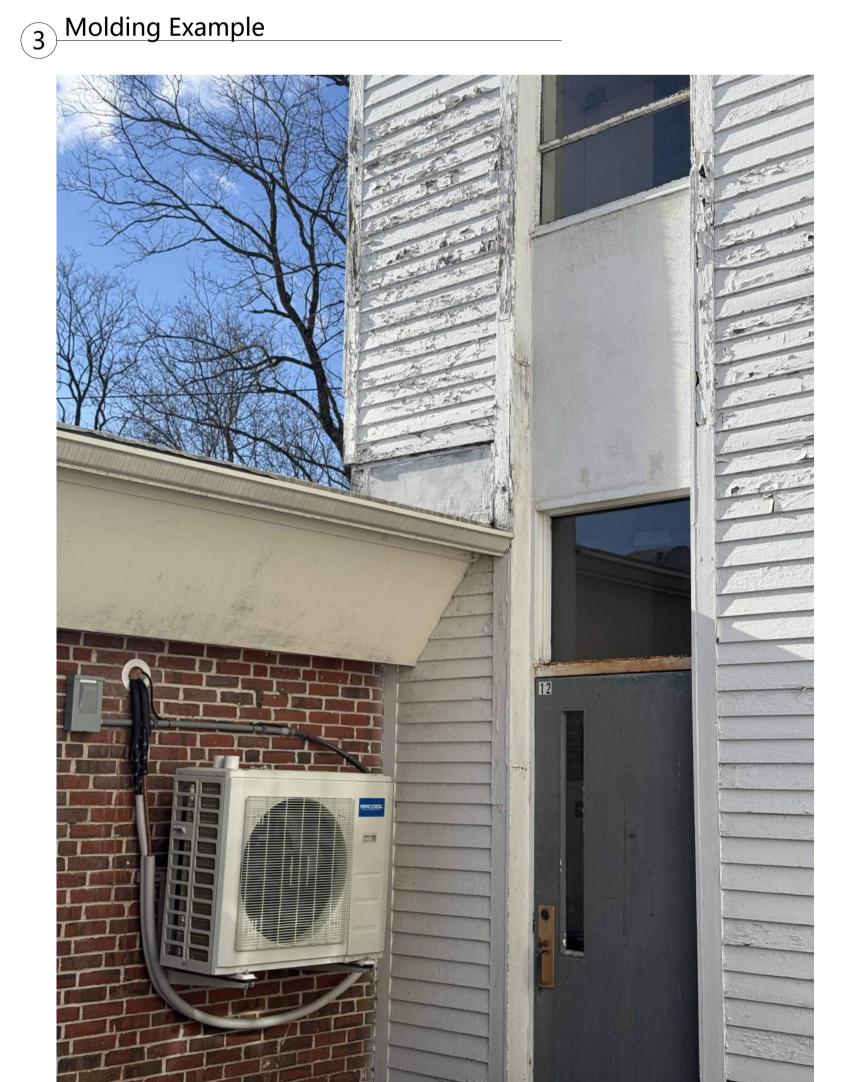

6 Siding Example



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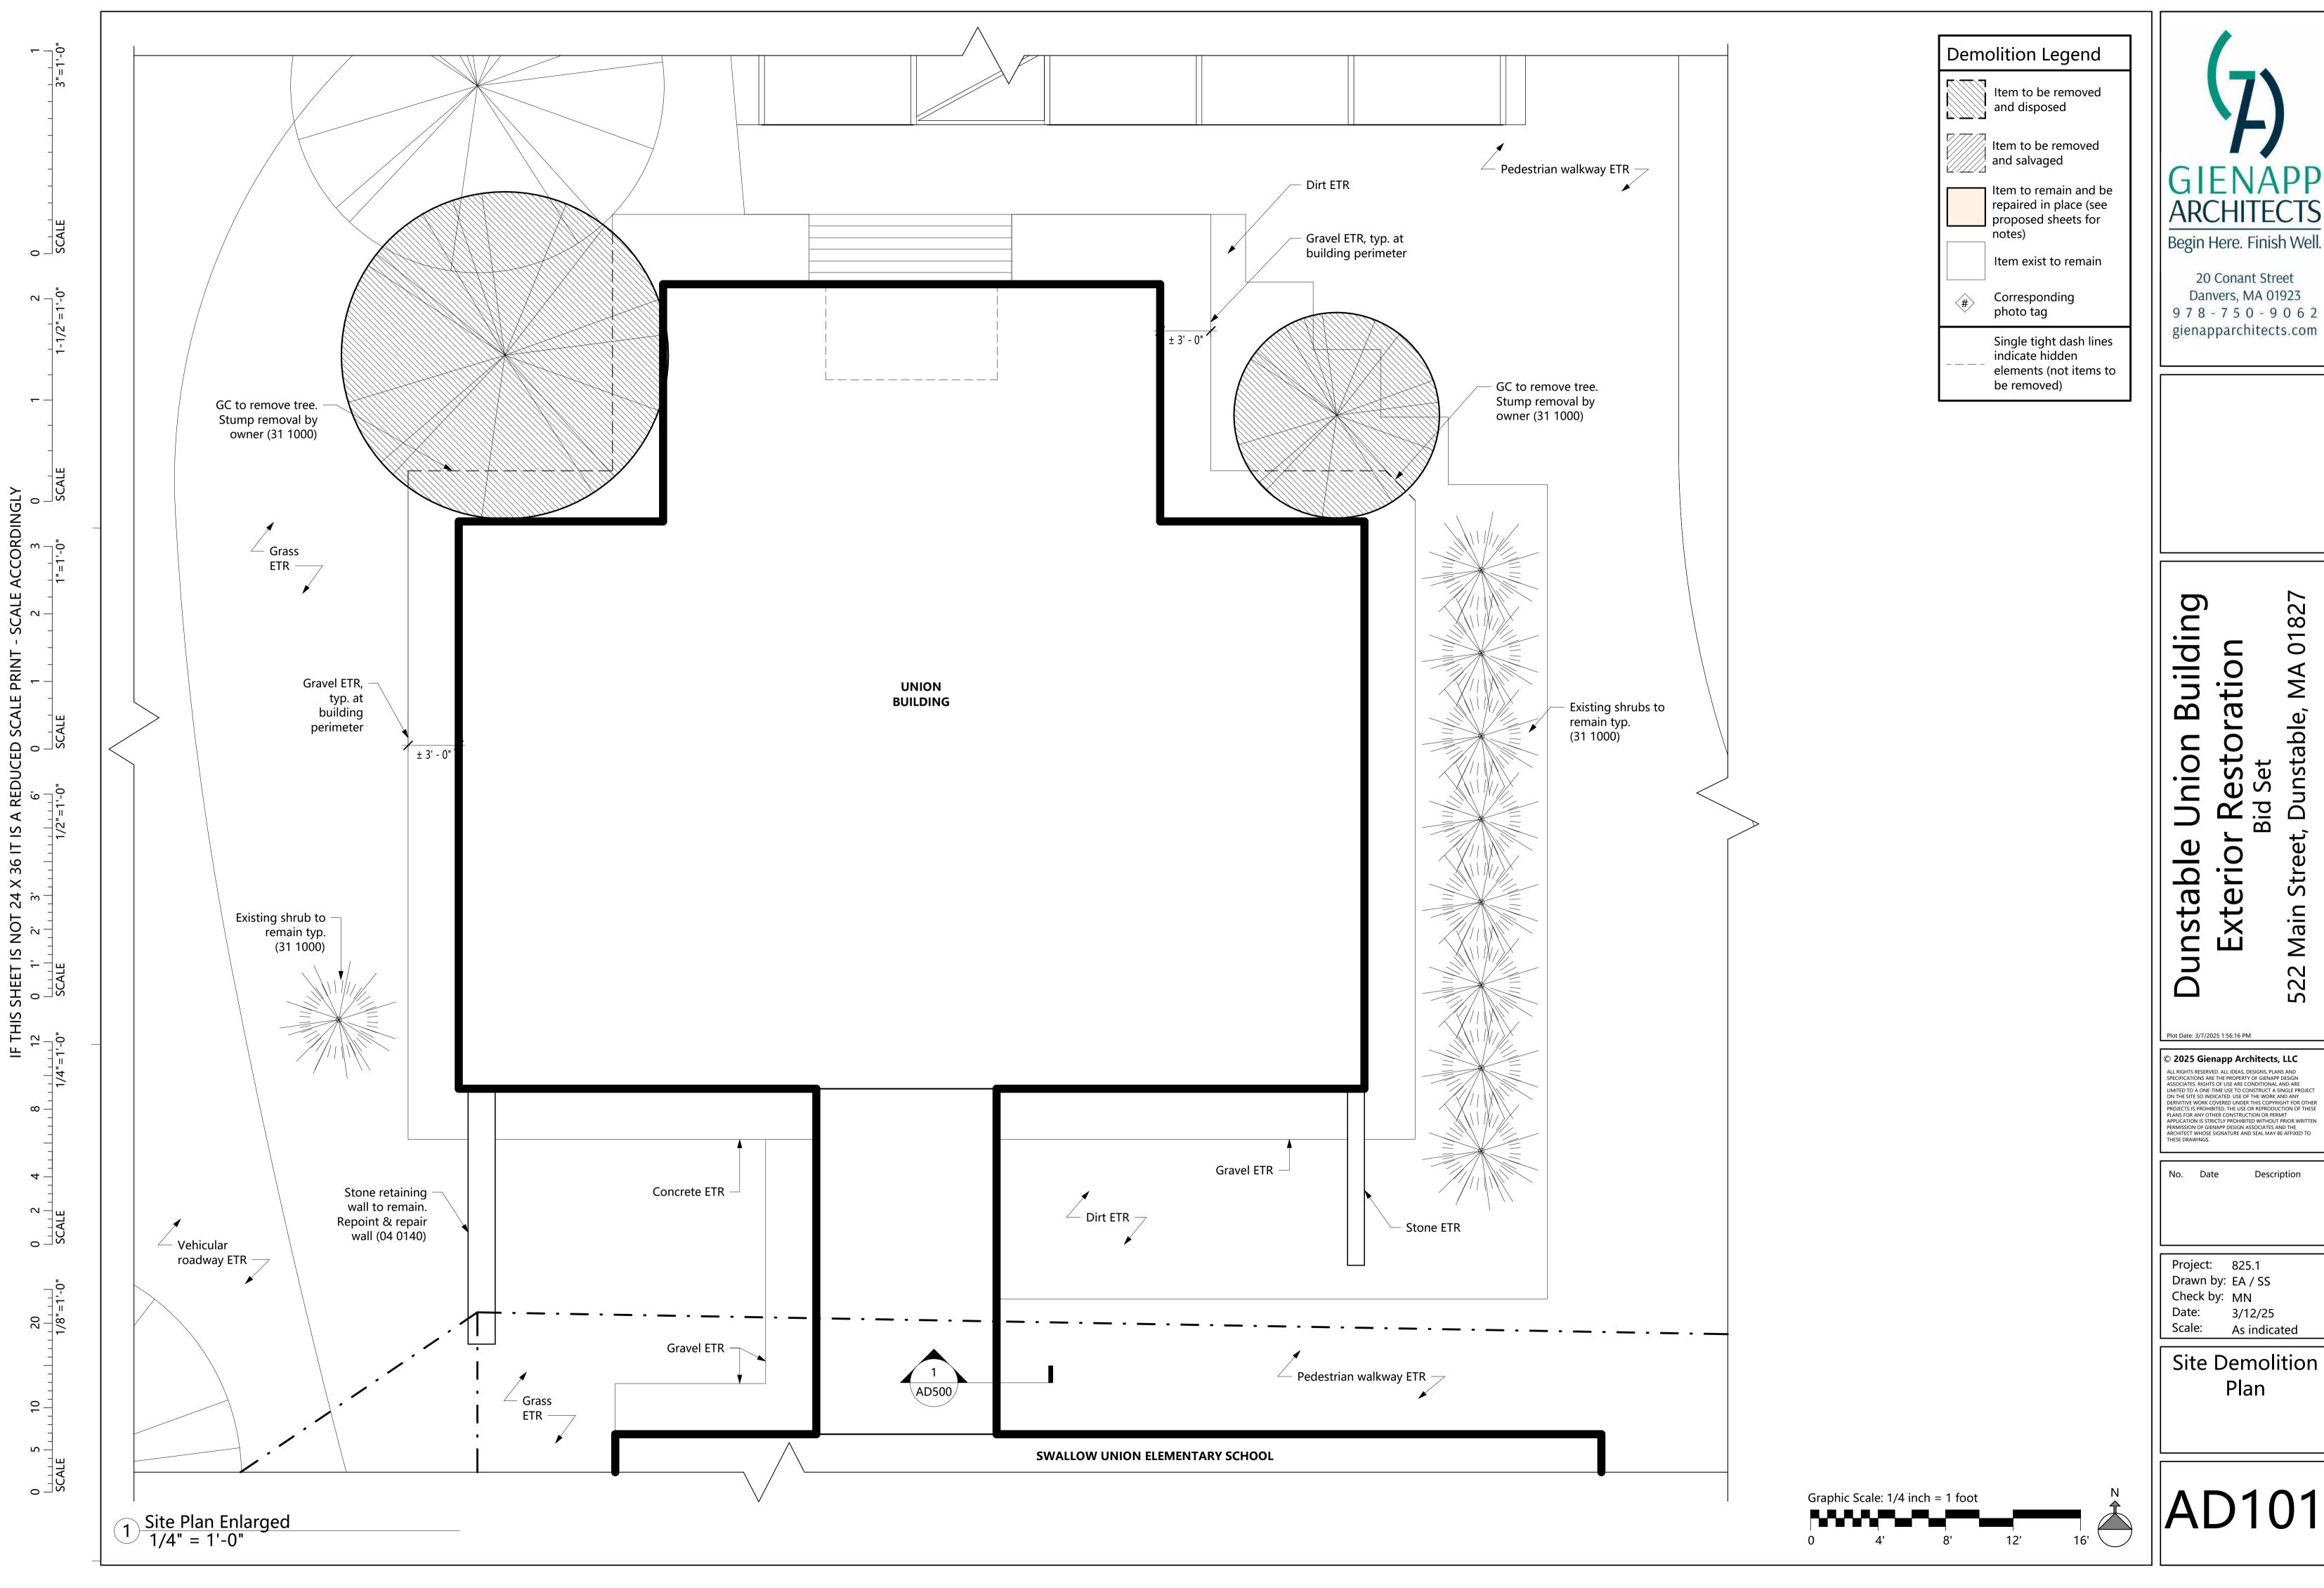
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Description

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**Existing Photos** 



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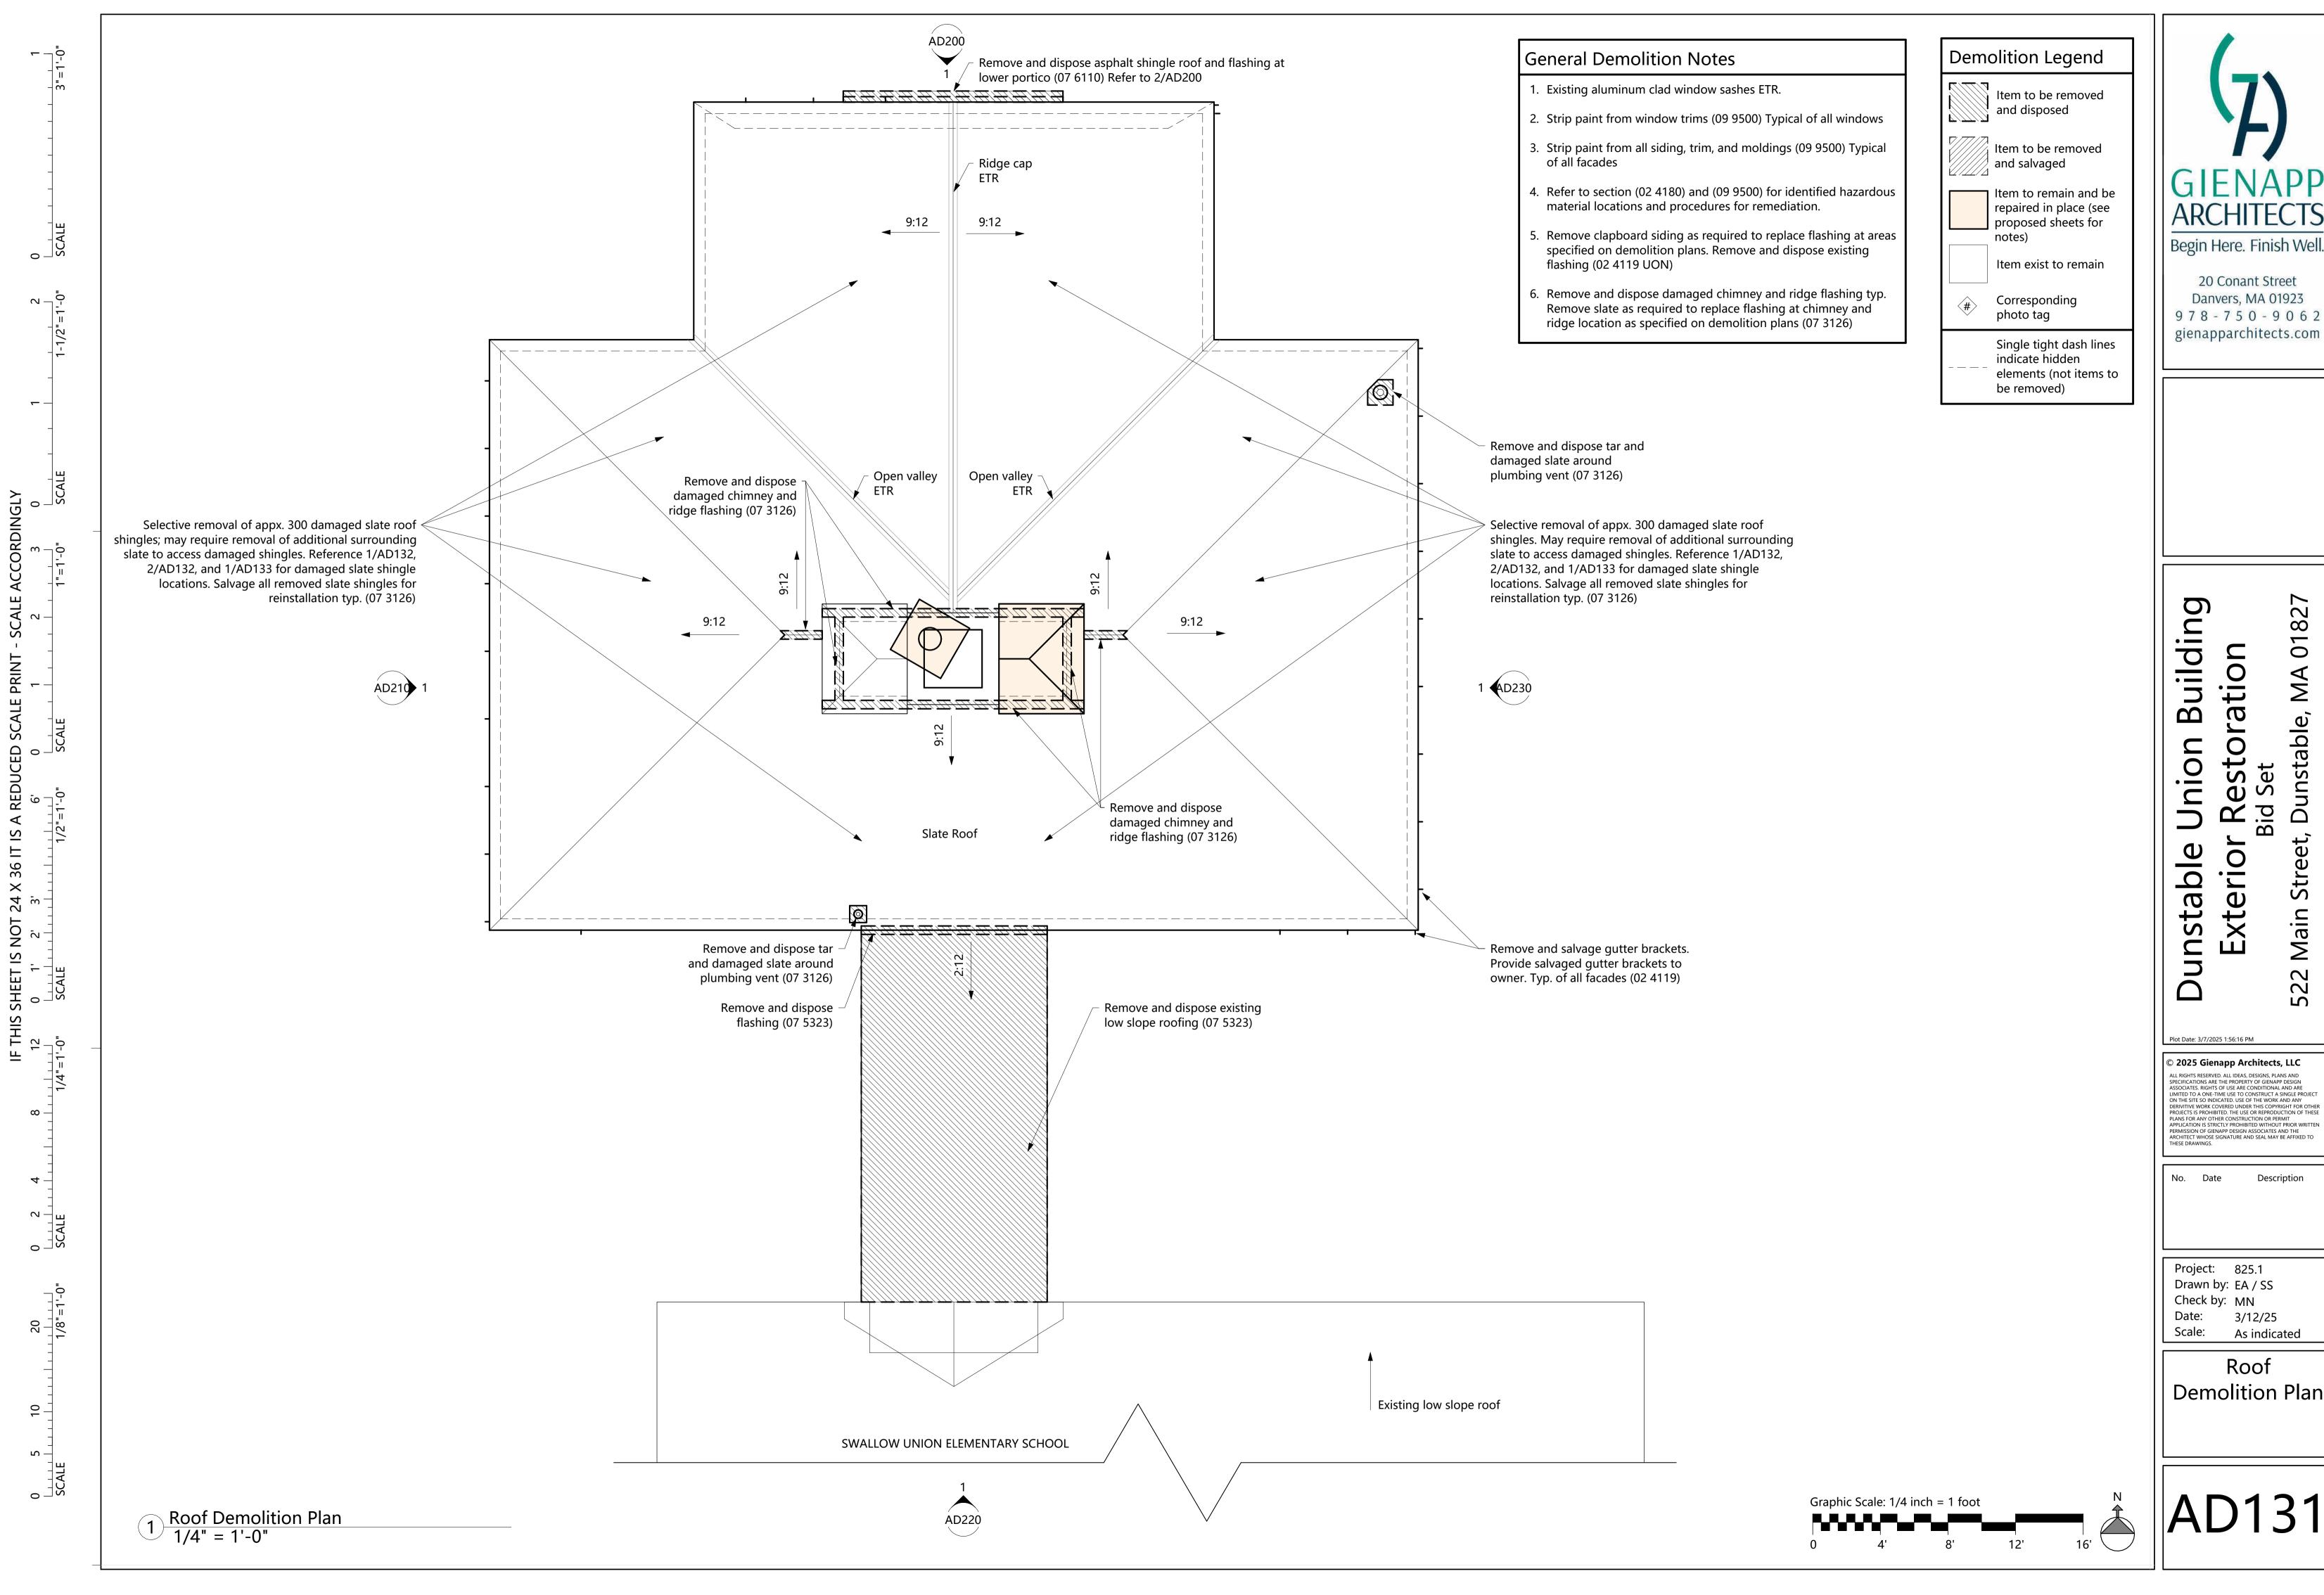
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Description

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Plan



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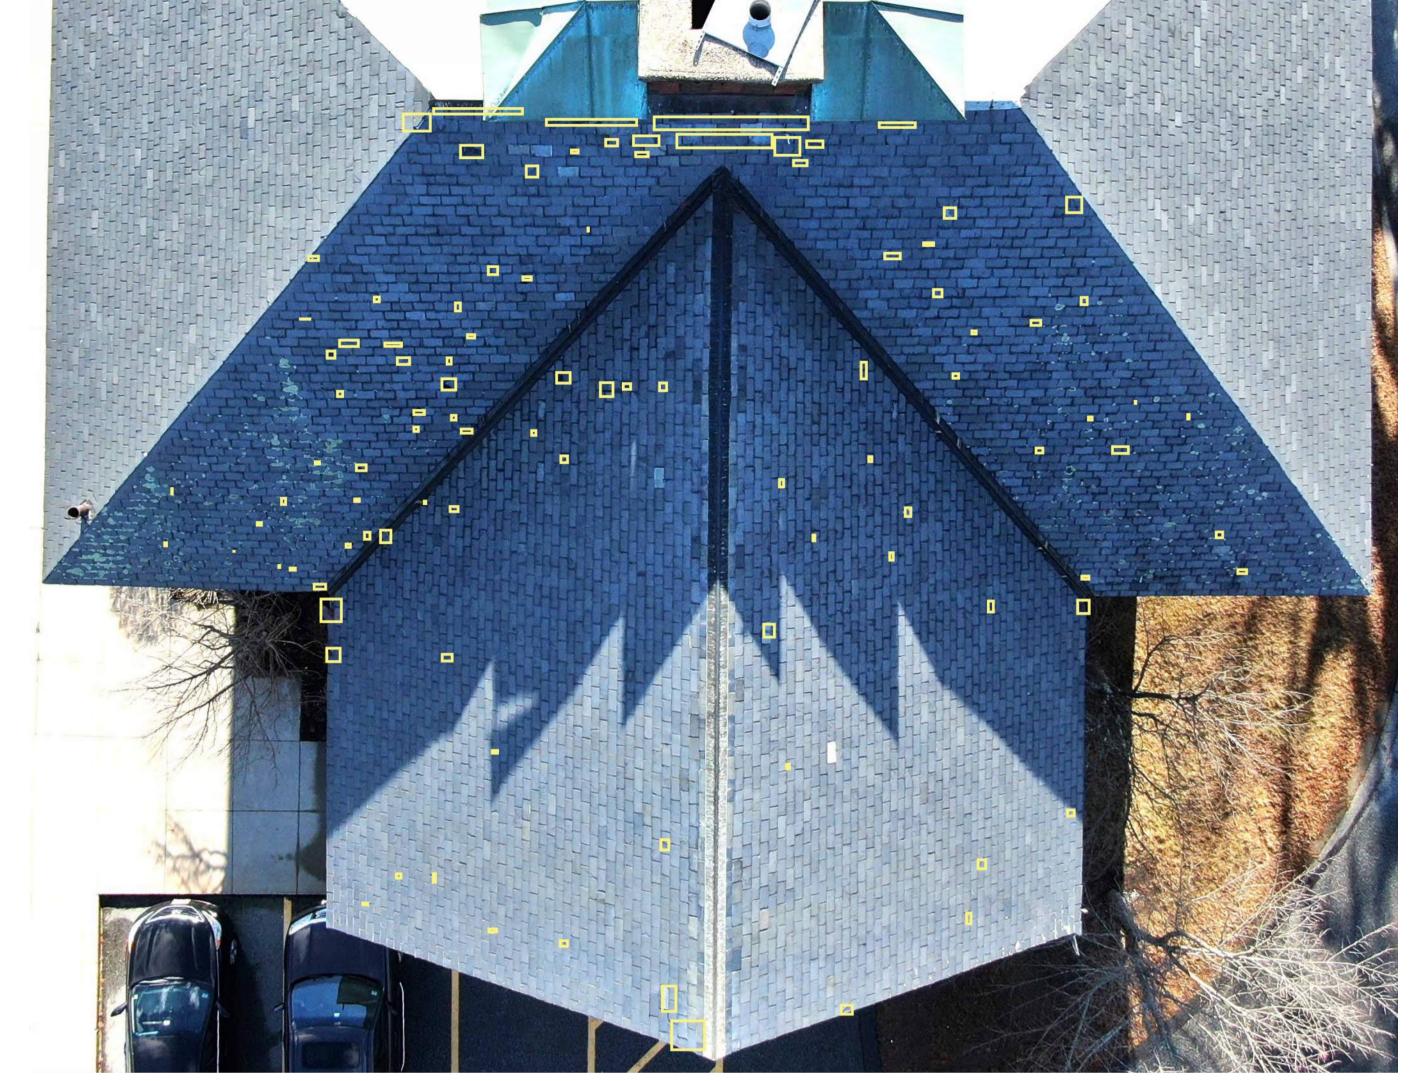
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Roof **Demolition Plan** 

6 -

5 —



1 North Roof Areas of Damage 1/8" = 1'-0"



2 East and West Roof Areas of Damage 1/8" = 1'-0"

### Demolition Legend



Appx. 300 damaged slate roof shingles and selective roof accessories. Slate shingles to be removed and salvaged for reinstallation (07 3126). Roof accessories to be repaired in place.

Note: See 1/AD131 for Roof Demolition Plan. See 1/A131 for Proposed Roof Plan.



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## Building **Restoration** r **Restoral** Bid Set t, Dunstable, I unstable Exterior

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Main Street,

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No. Date Description

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Date: 3/12/25 Scale: As indicated

North, East, and West Roof Areas of Damage

2 | -1-0"

4 –

9 -

Demolition Legend



Appx. 300 damaged slate roof shingles and selective roof accessories. Slate shingles to be removed and salvaged for reinstallation (07 3126). Roof accessories to be repaired in place.

Note: See 1/AD131 for Roof Demolition Plan. See 1/A131 for Proposed Roof Plan.



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Building



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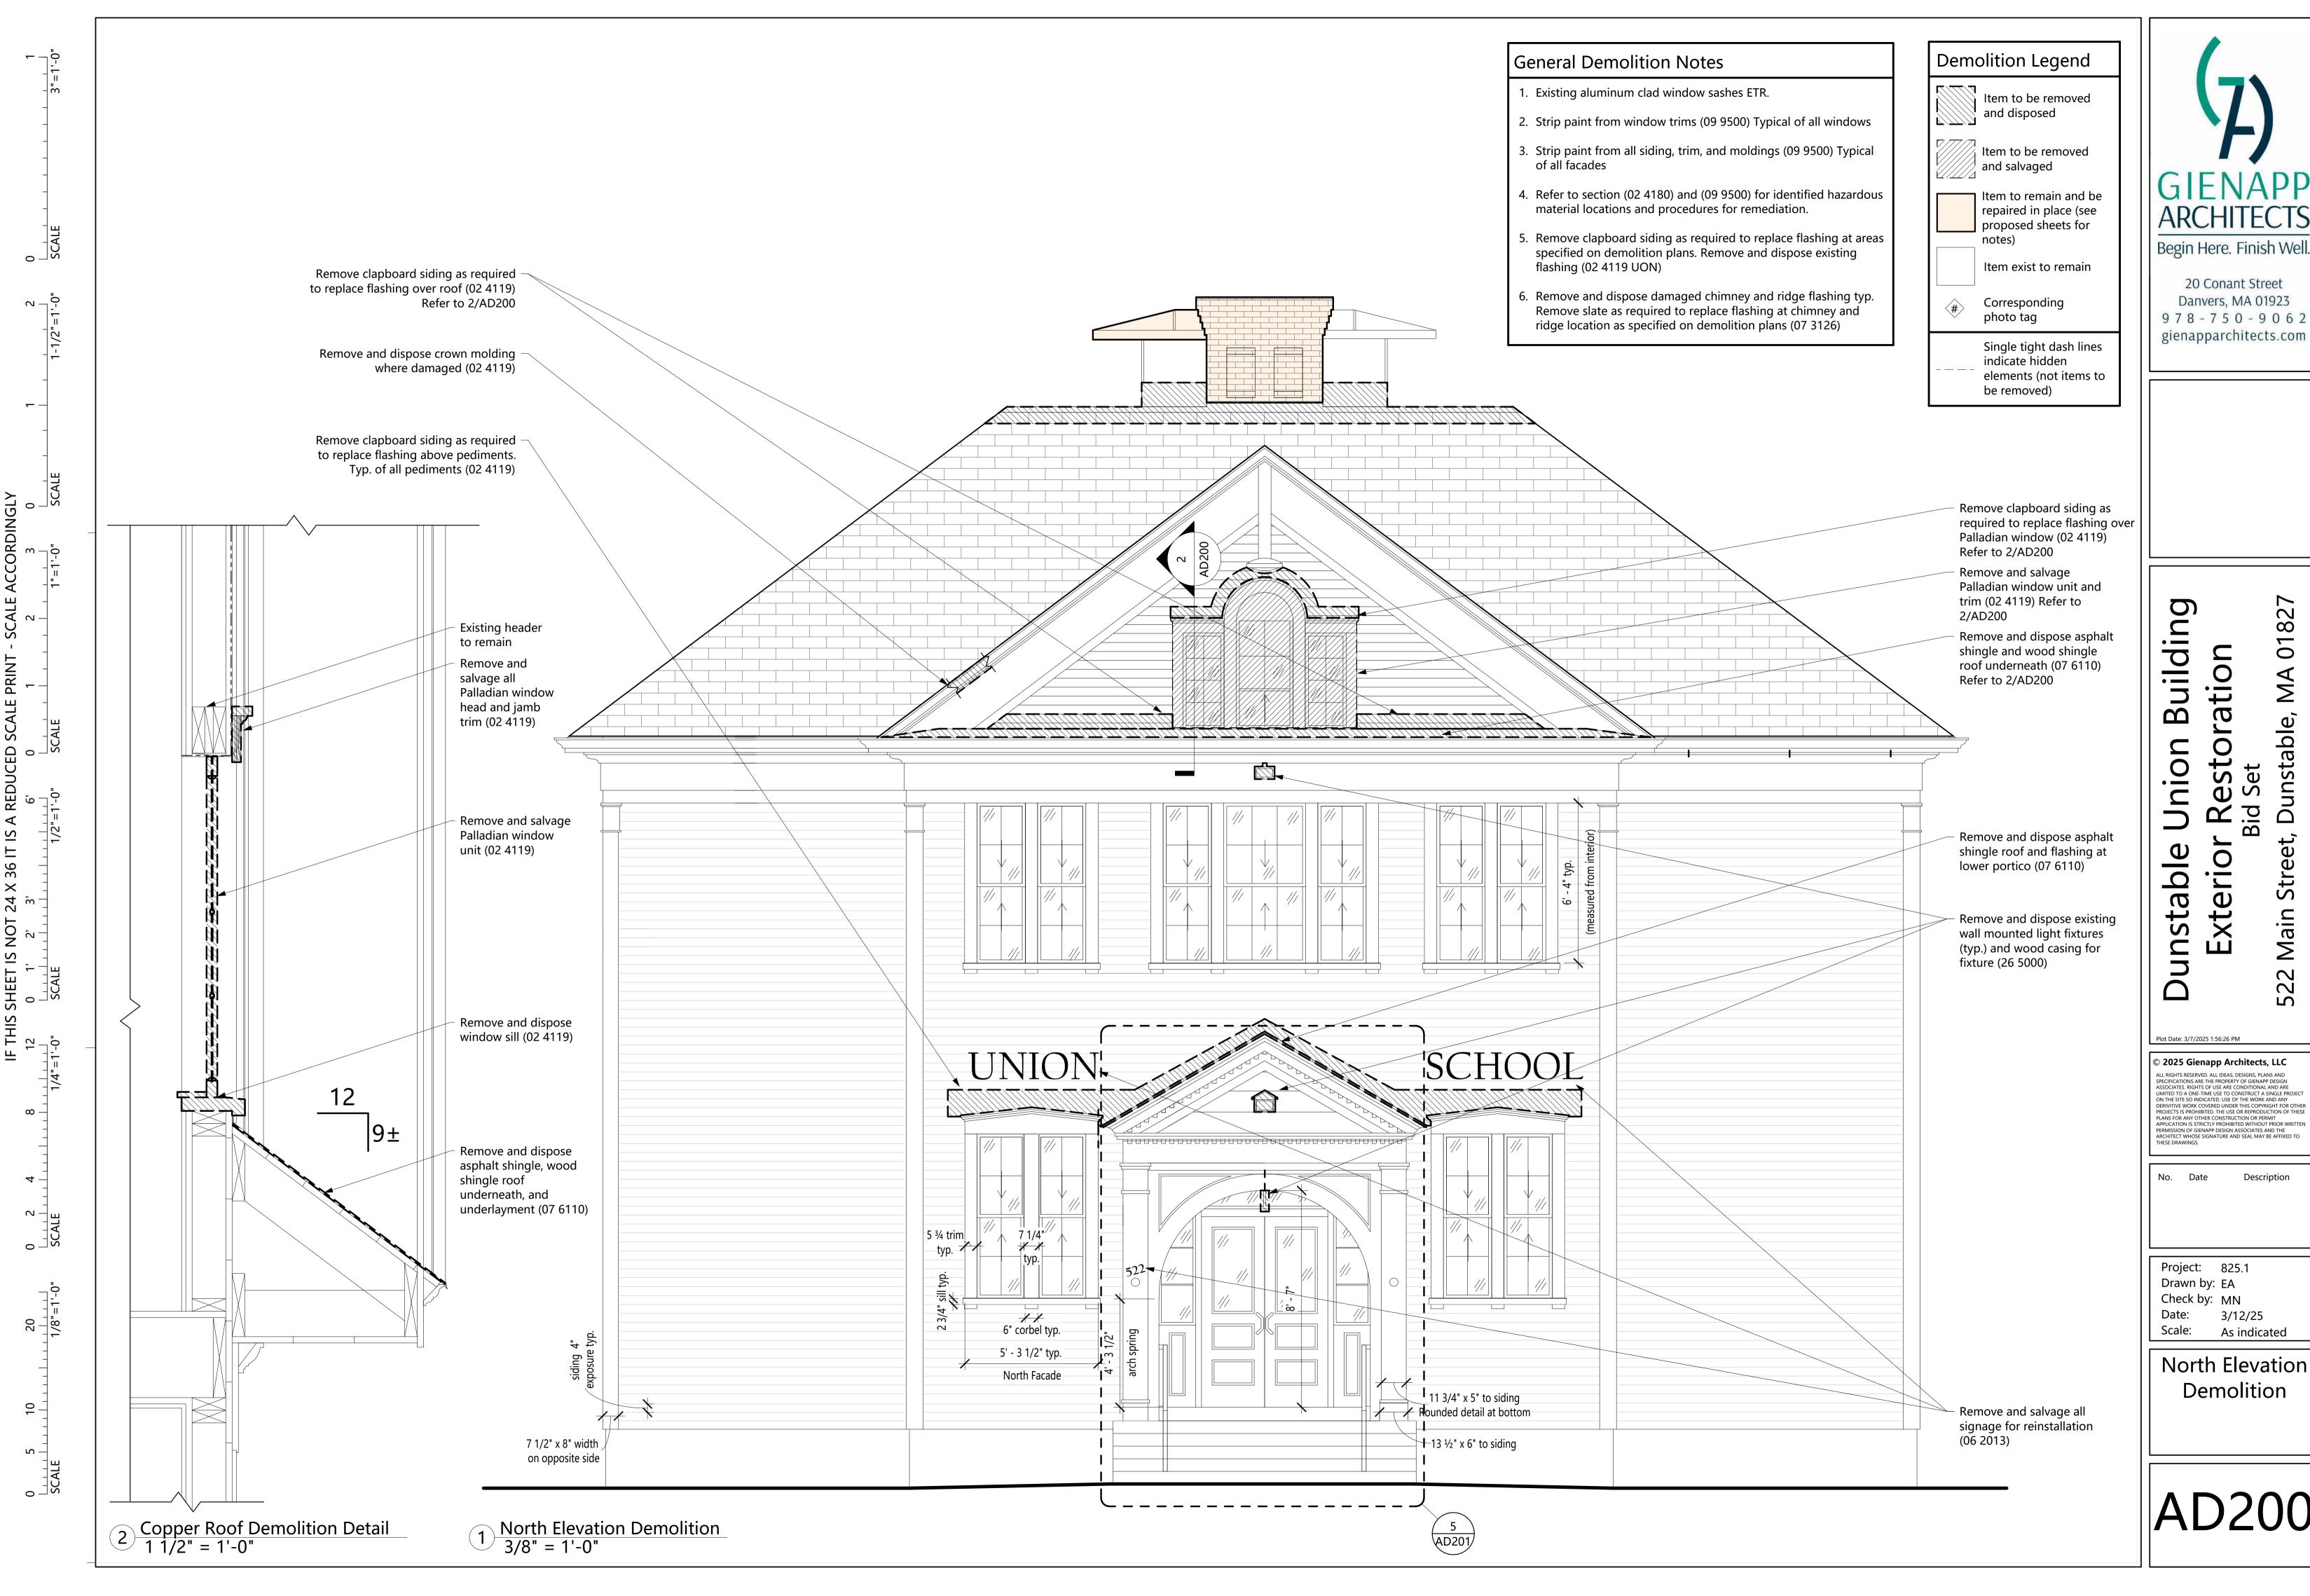
Description

No. Date

Project: 825.1 Drawn by: EA / SS Check by: MN
Date: 3/12/25 Date: 3/12/25
Scale: As indicated

> South Roof Areas of Damage





> 20 Conant Street Danvers, MA 01923 978-750-9062 gienapparchitects.com

## ration 0 S Exterior

01827

Dunstable,

Street,

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Description

Project: 825.1

**North Elevation** Demolition






2 Portico Railing Connection





Portico Bead board Ceiling

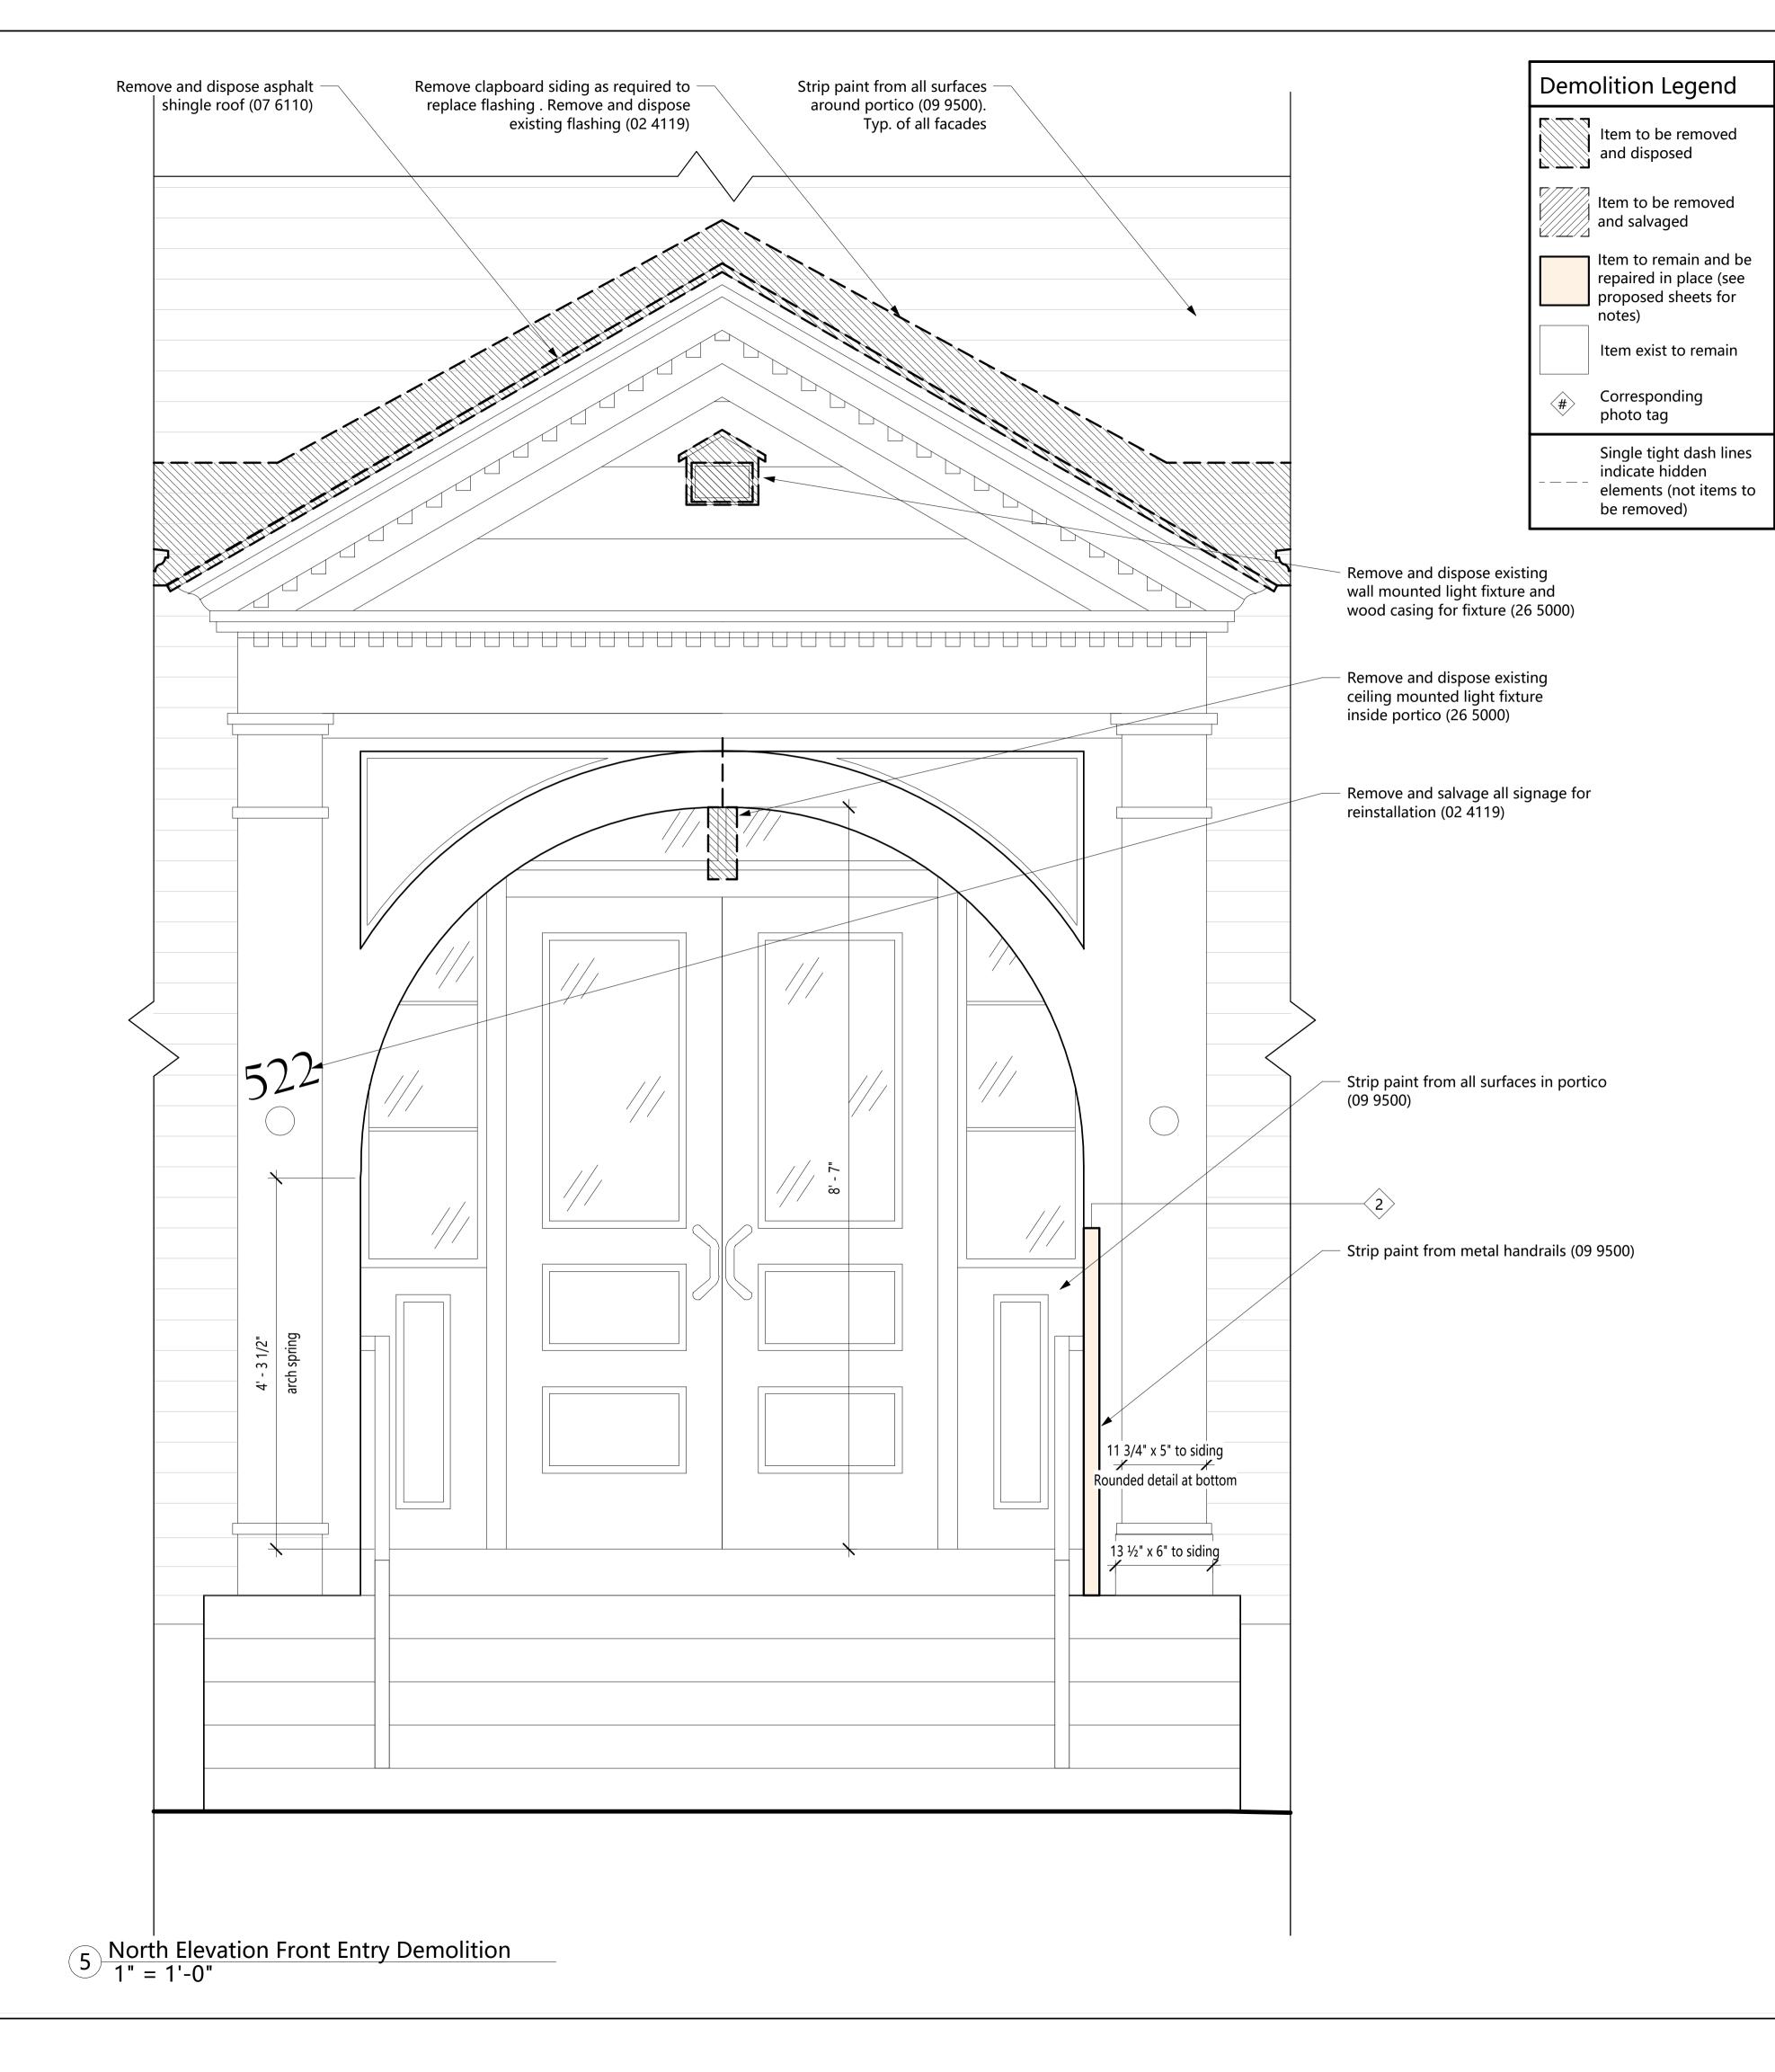

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## Building estoration Set <u>ā</u> Exterior unstable

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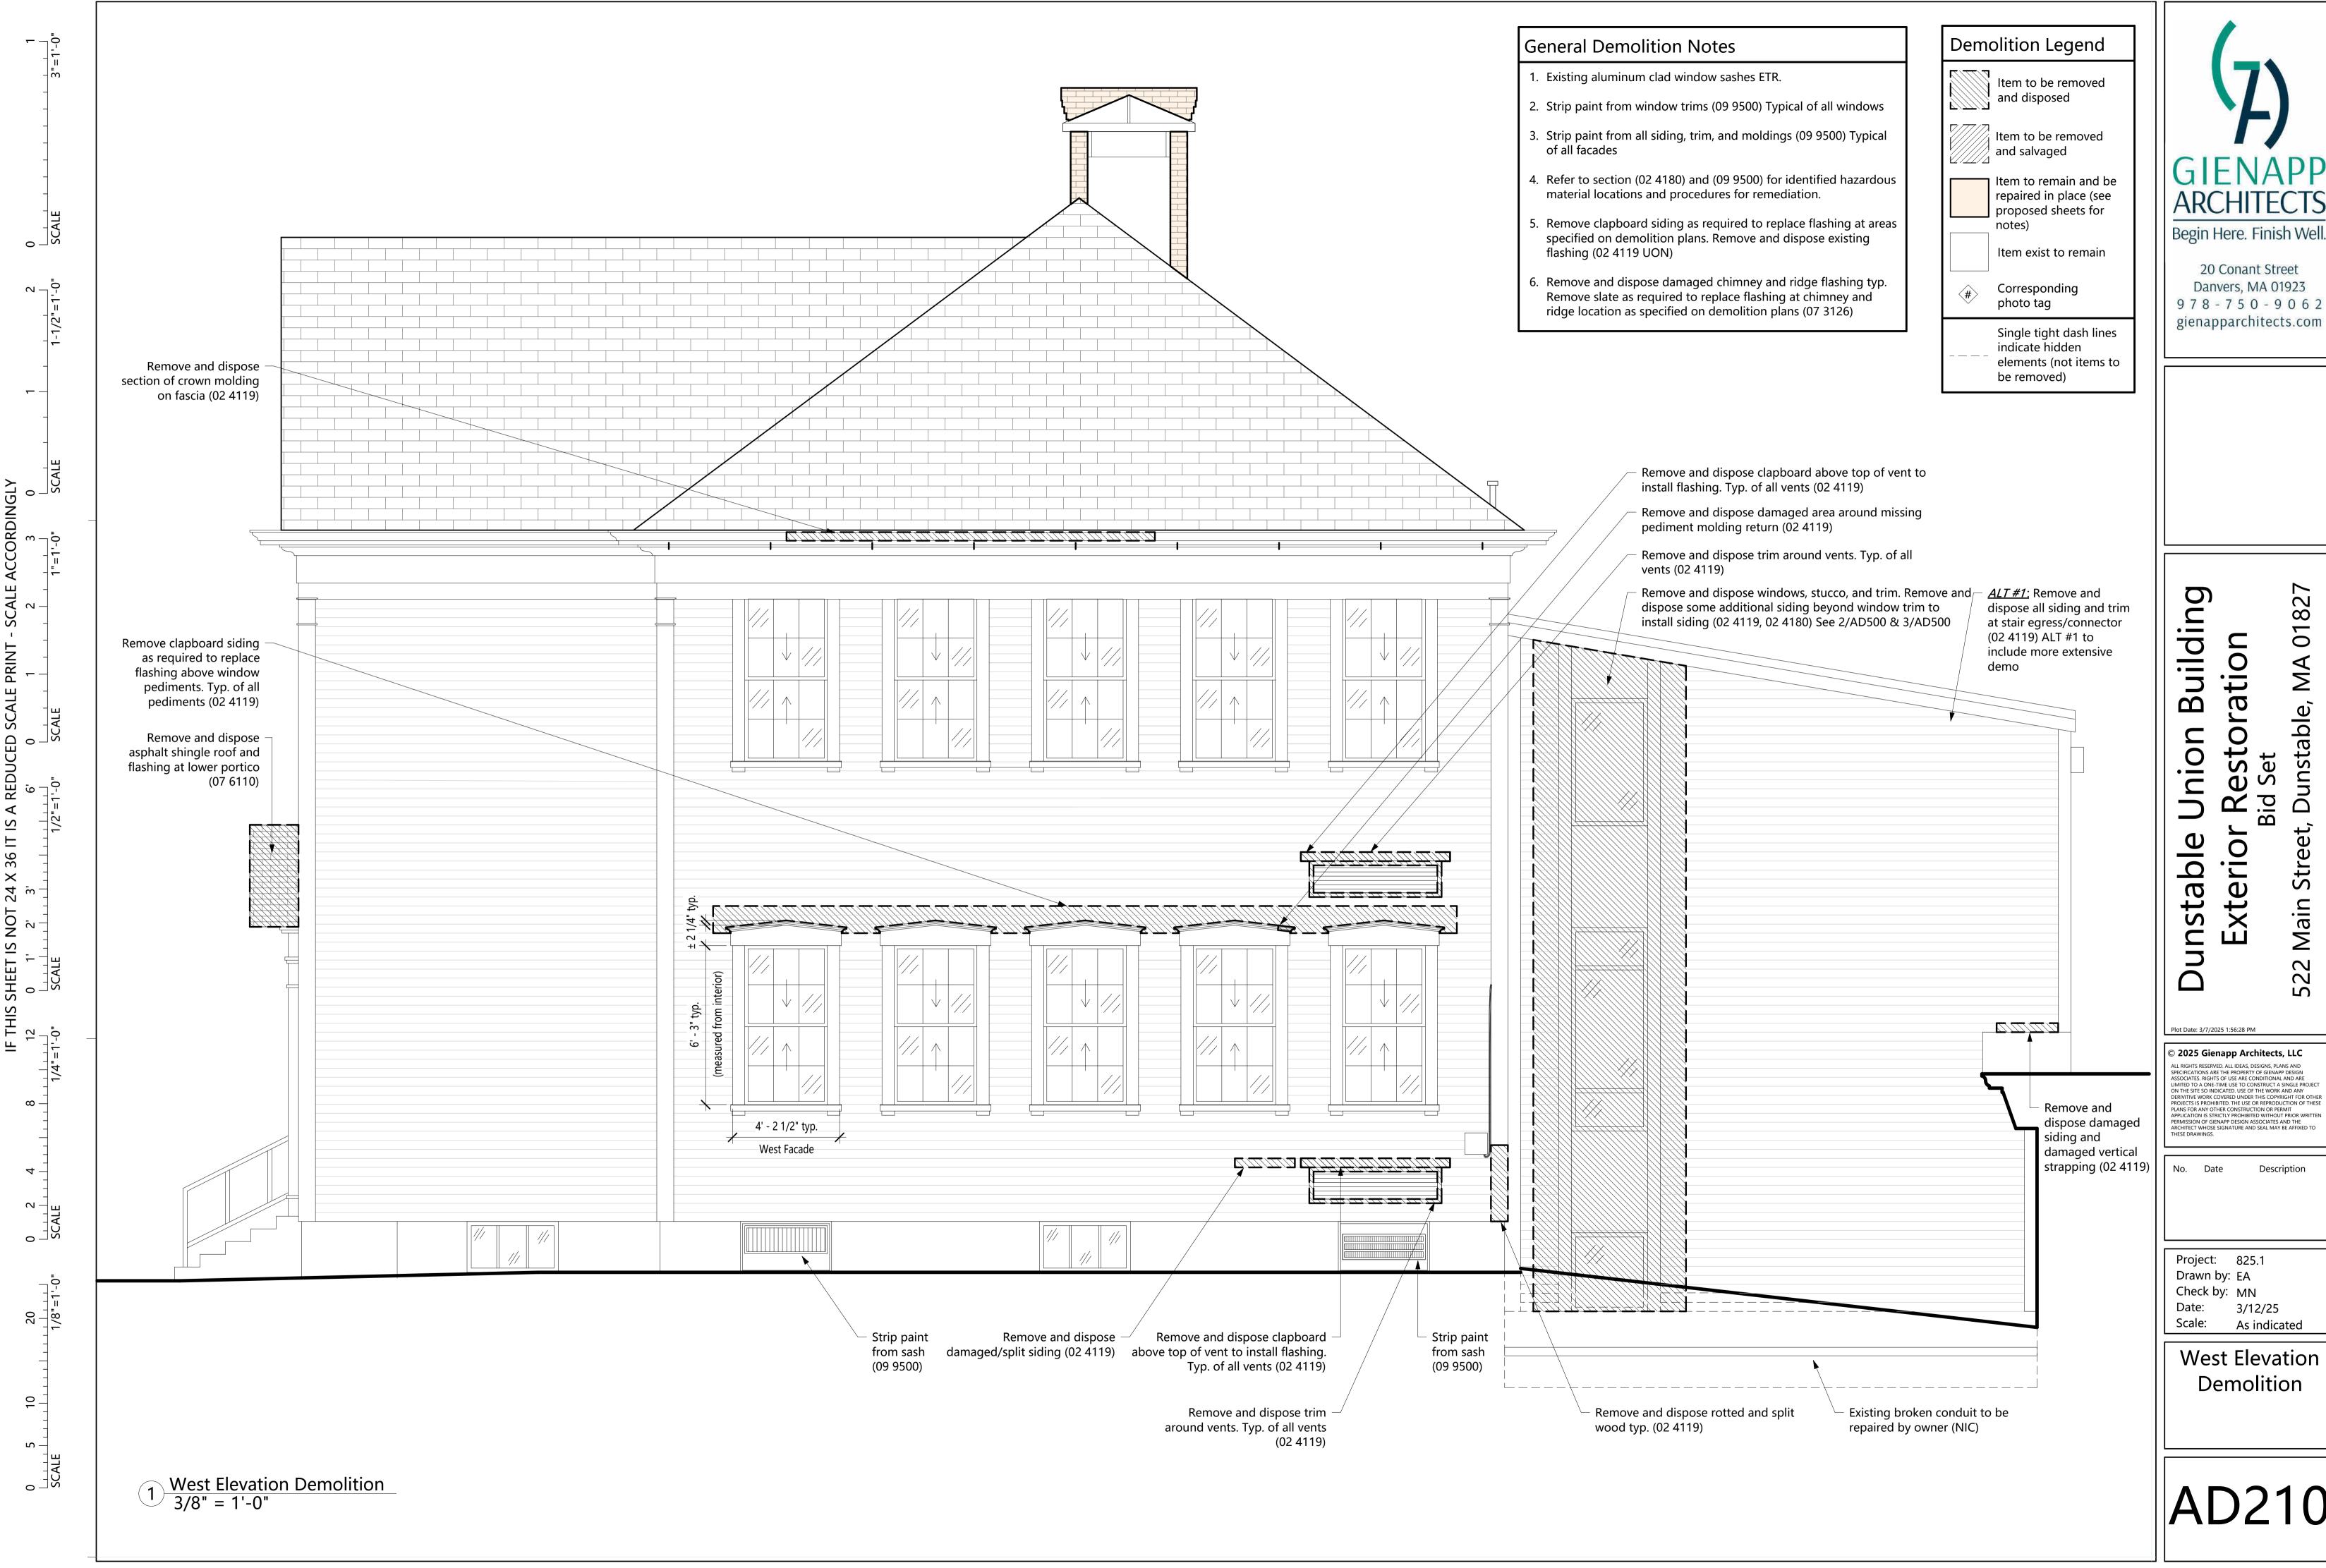
Main Street,

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Description

Project: 825.1 Drawn by: EA Check by: MN 3/12/25 Date: Scale: As indicated

North Elevation Front Entry Demolition



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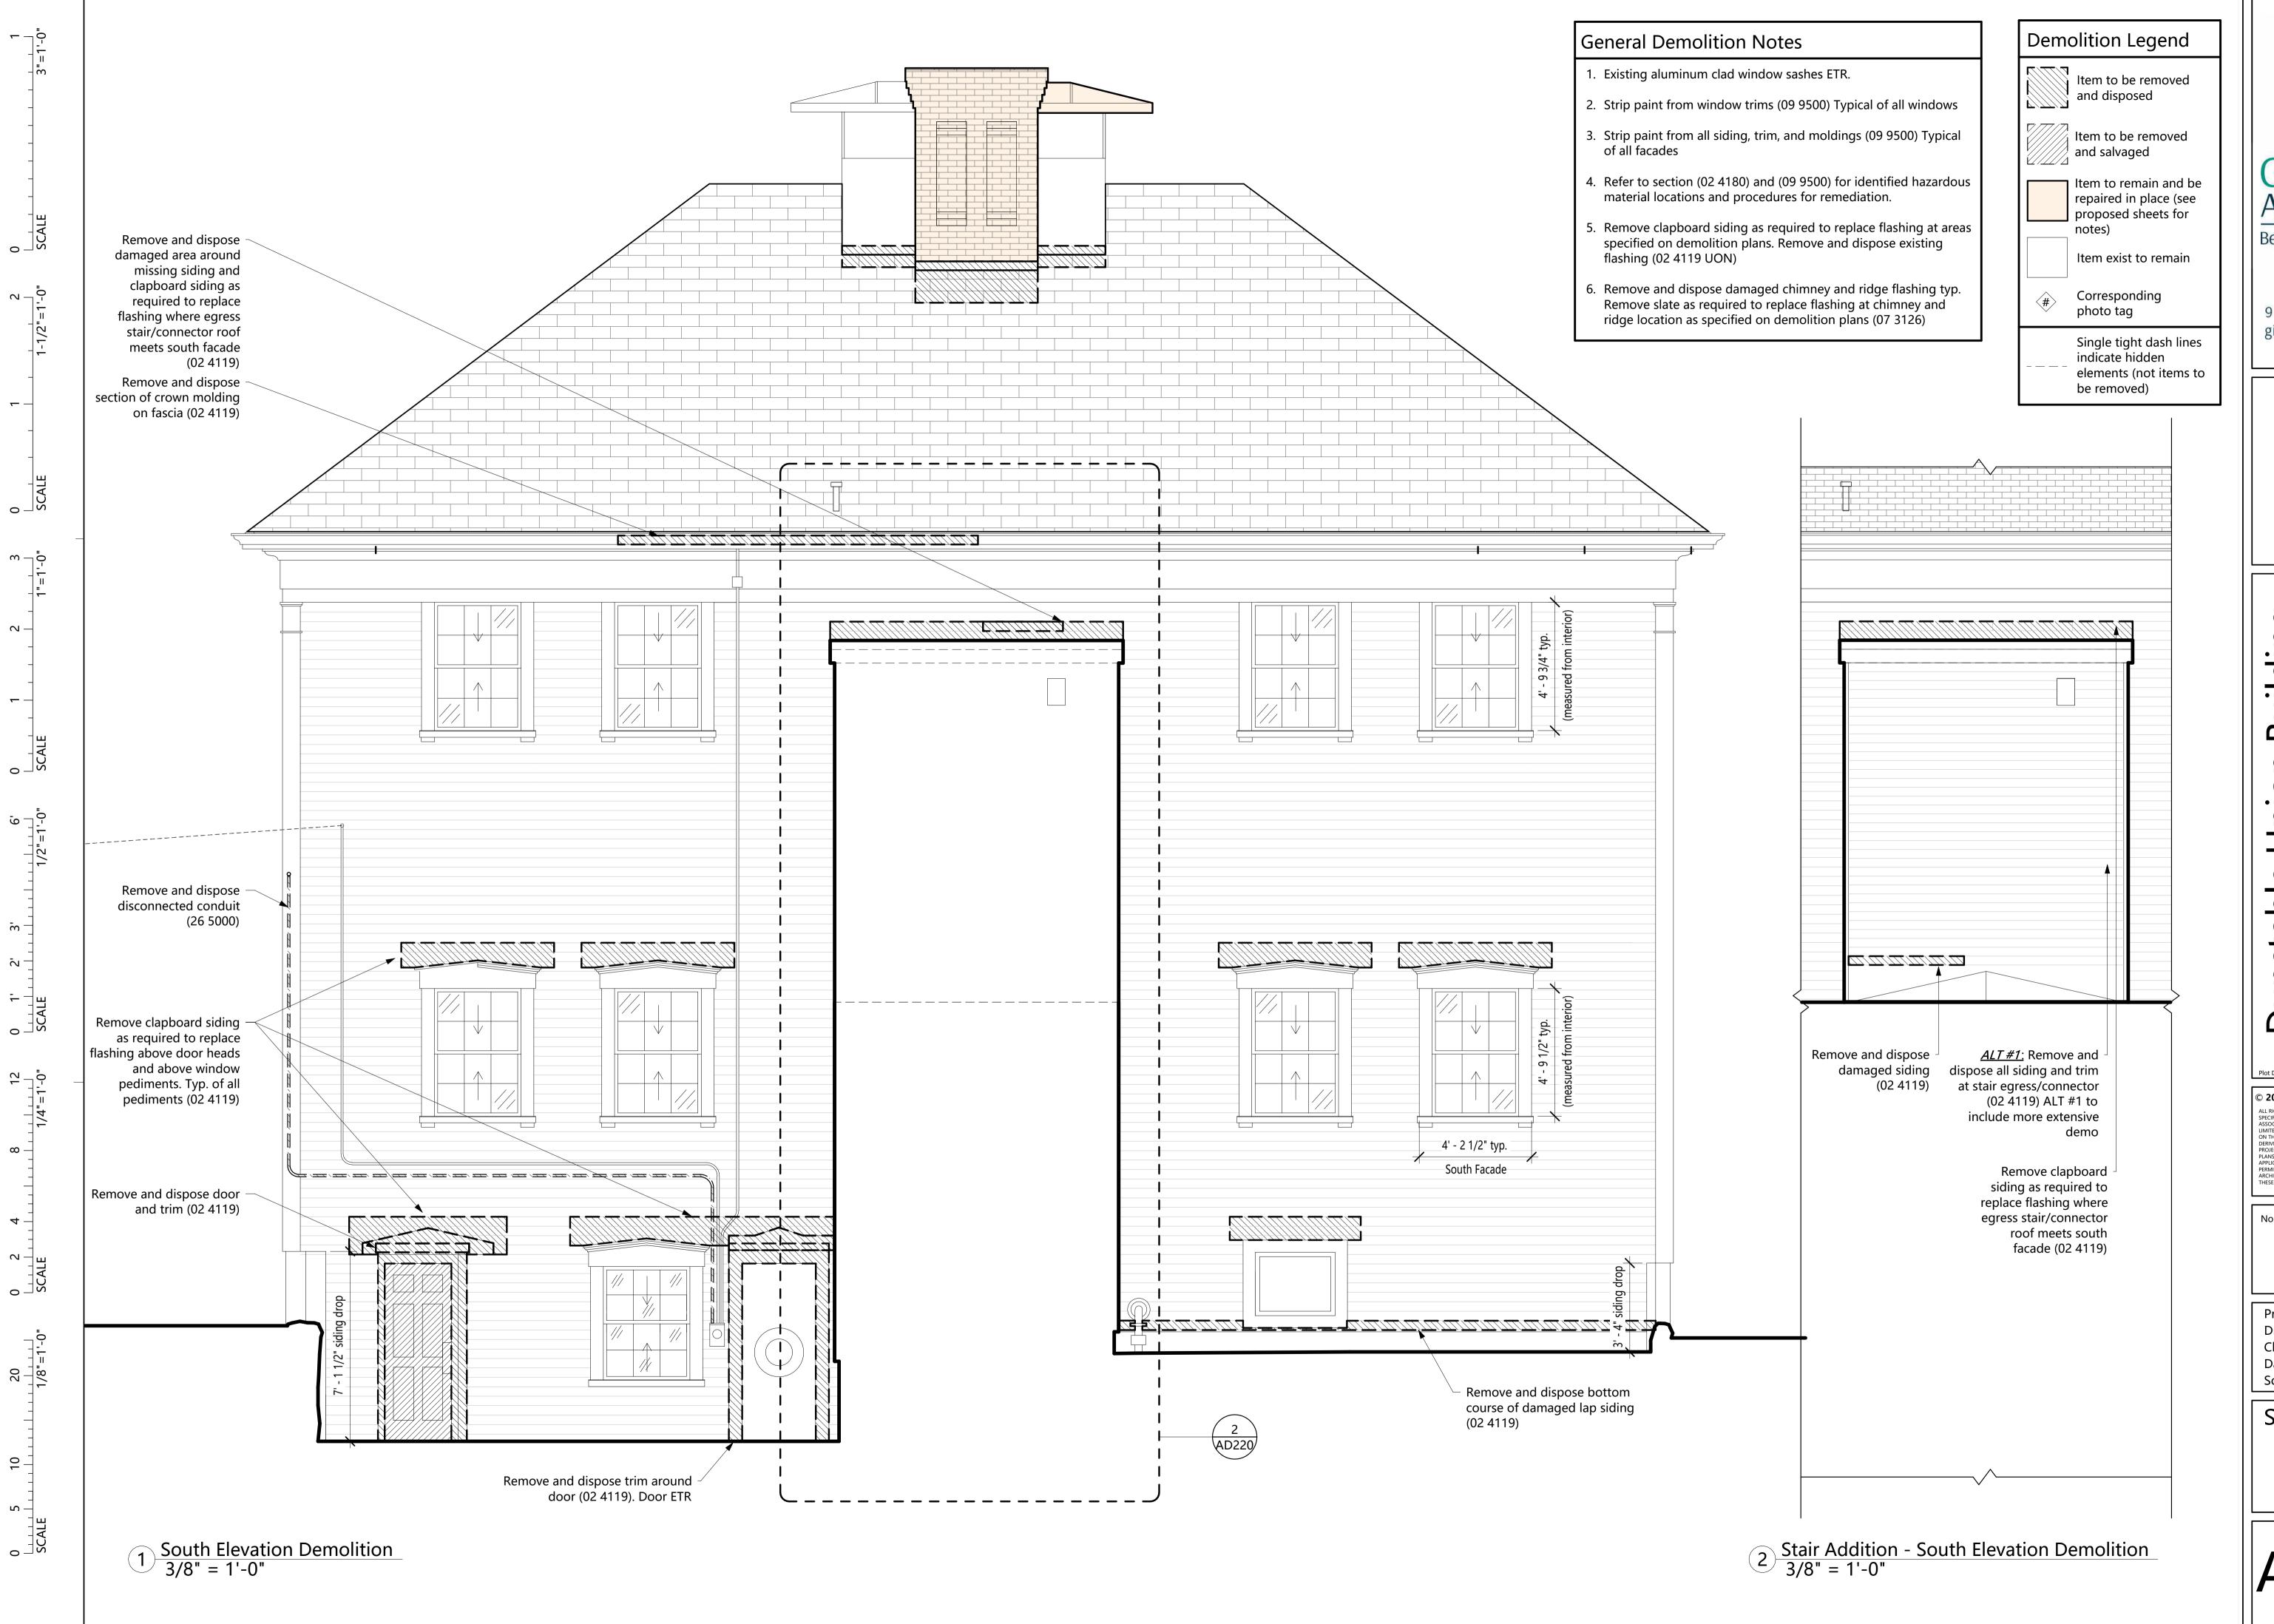
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Street,

Description

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Demolition



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Dunstable,

Street,

522


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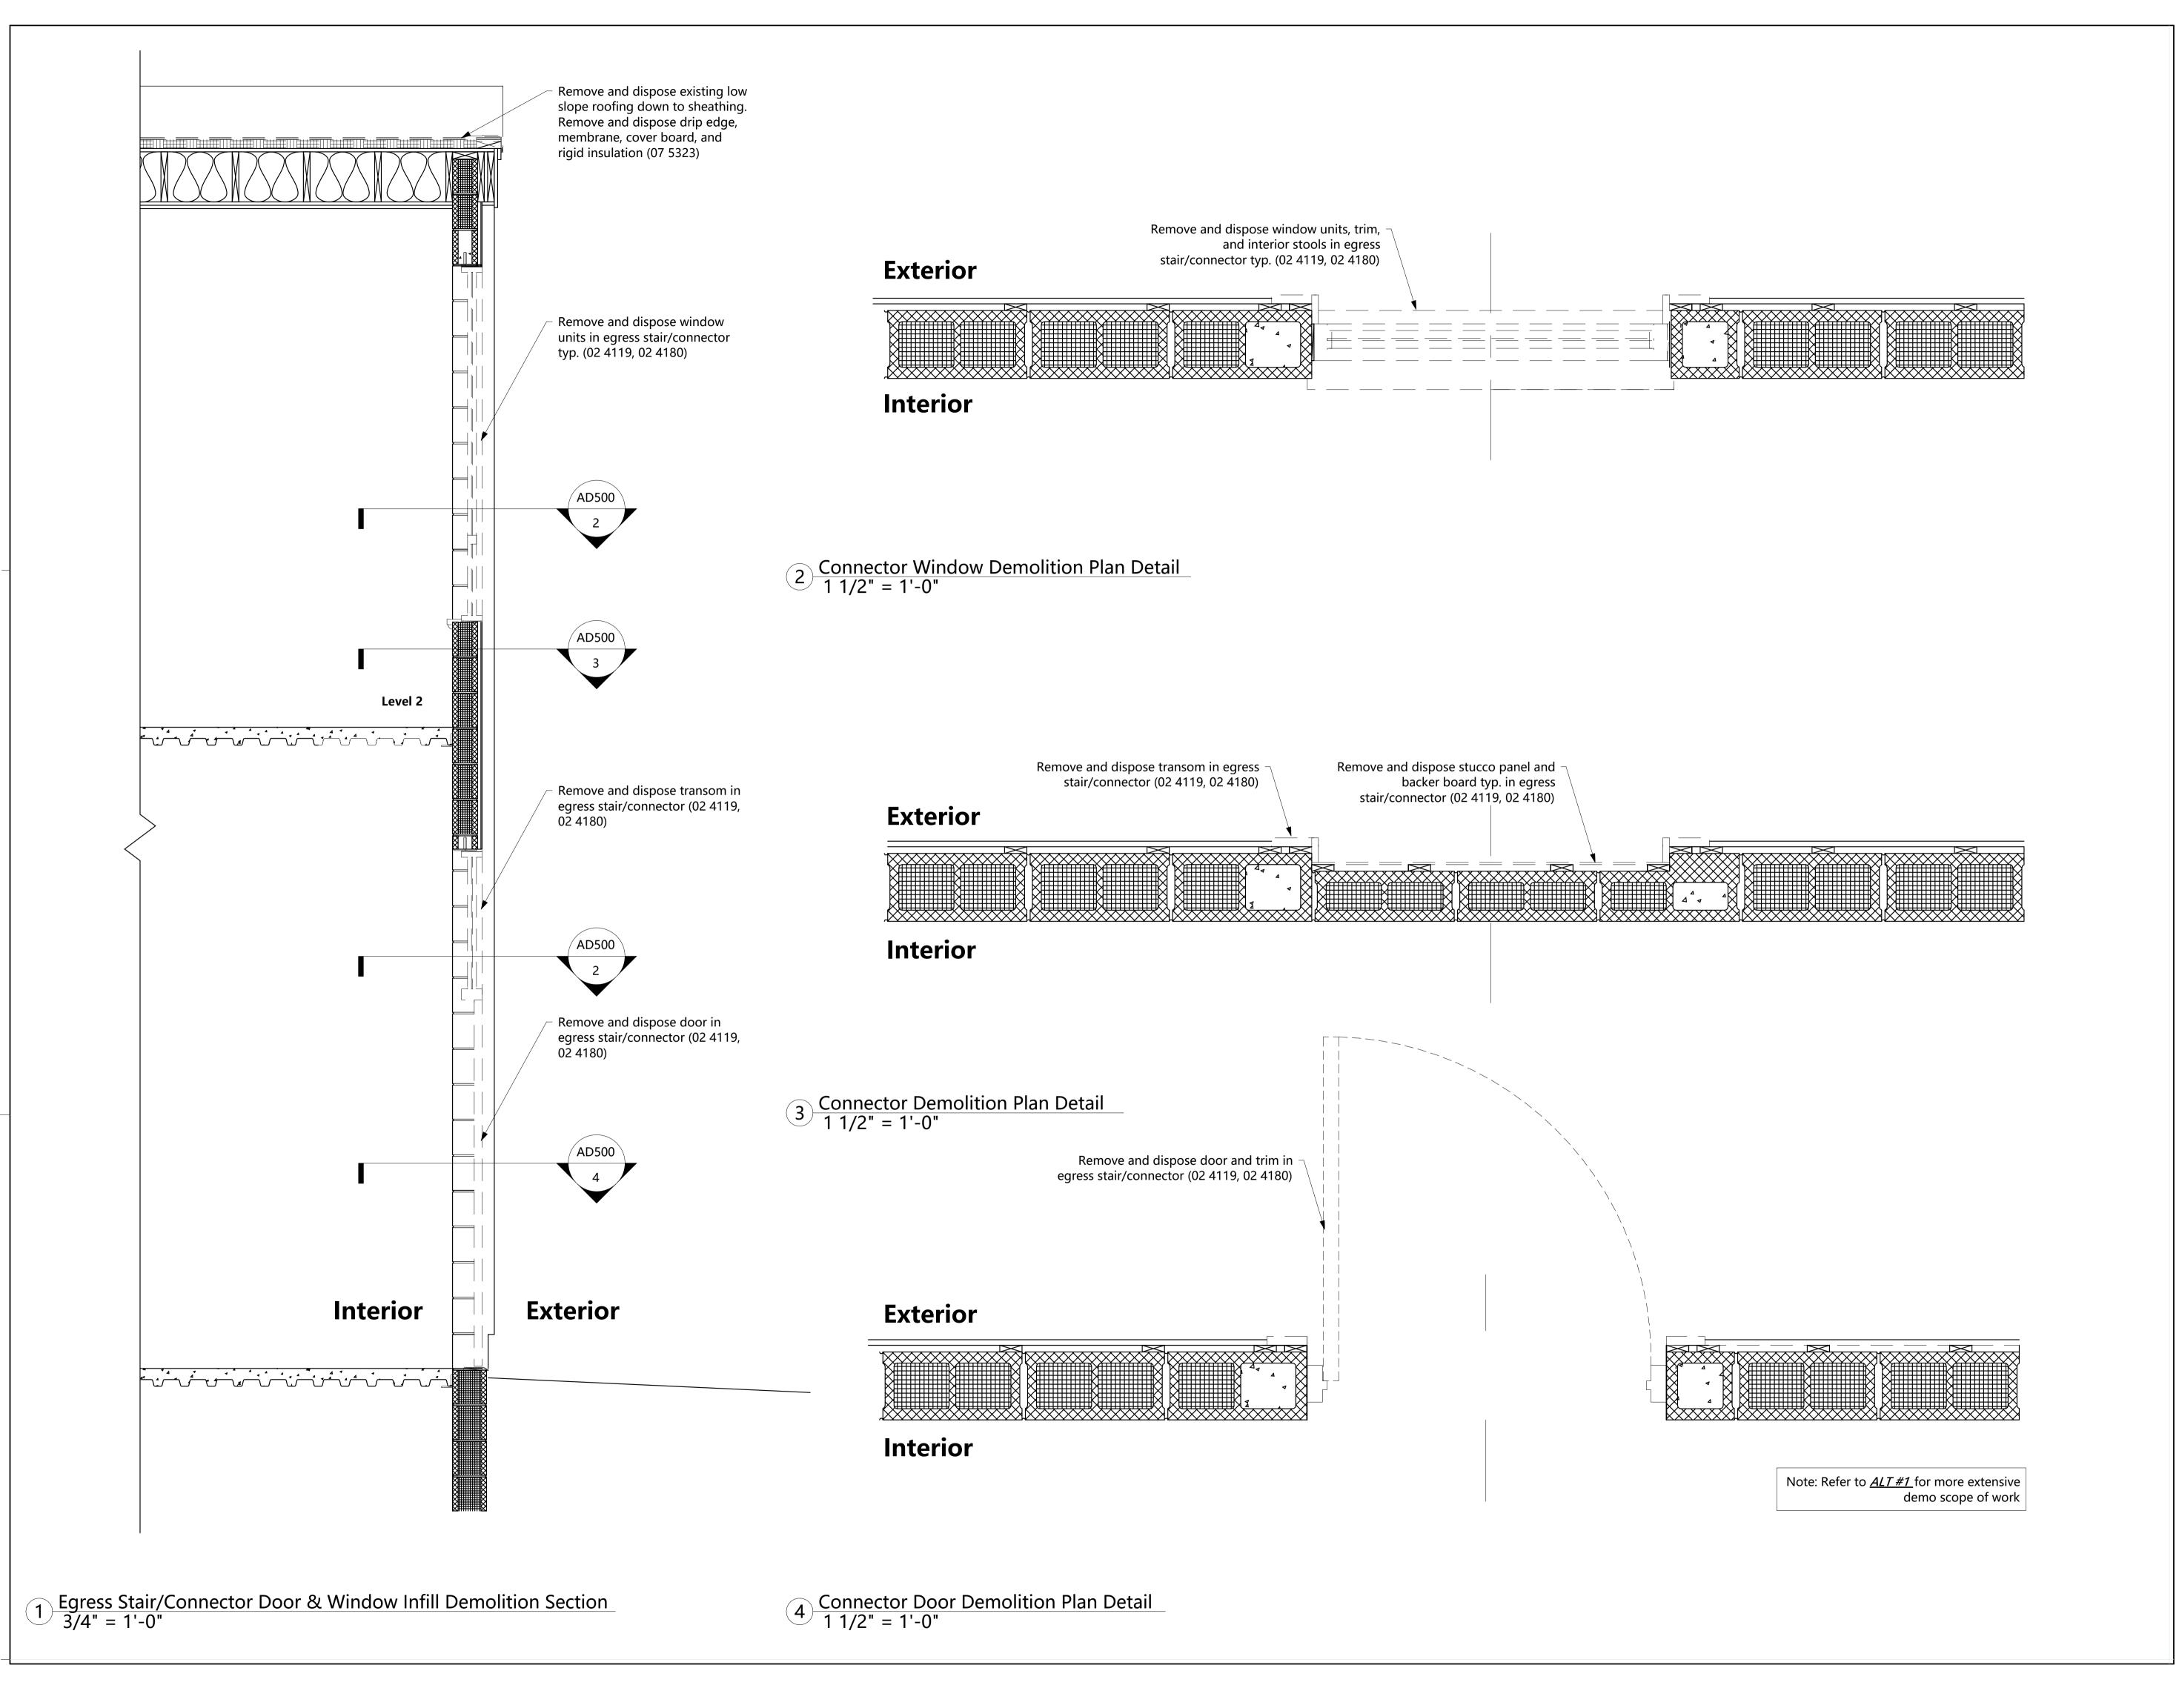
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. Date Description

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South Elevation Demolition





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GIENAPP ARCHITECTS

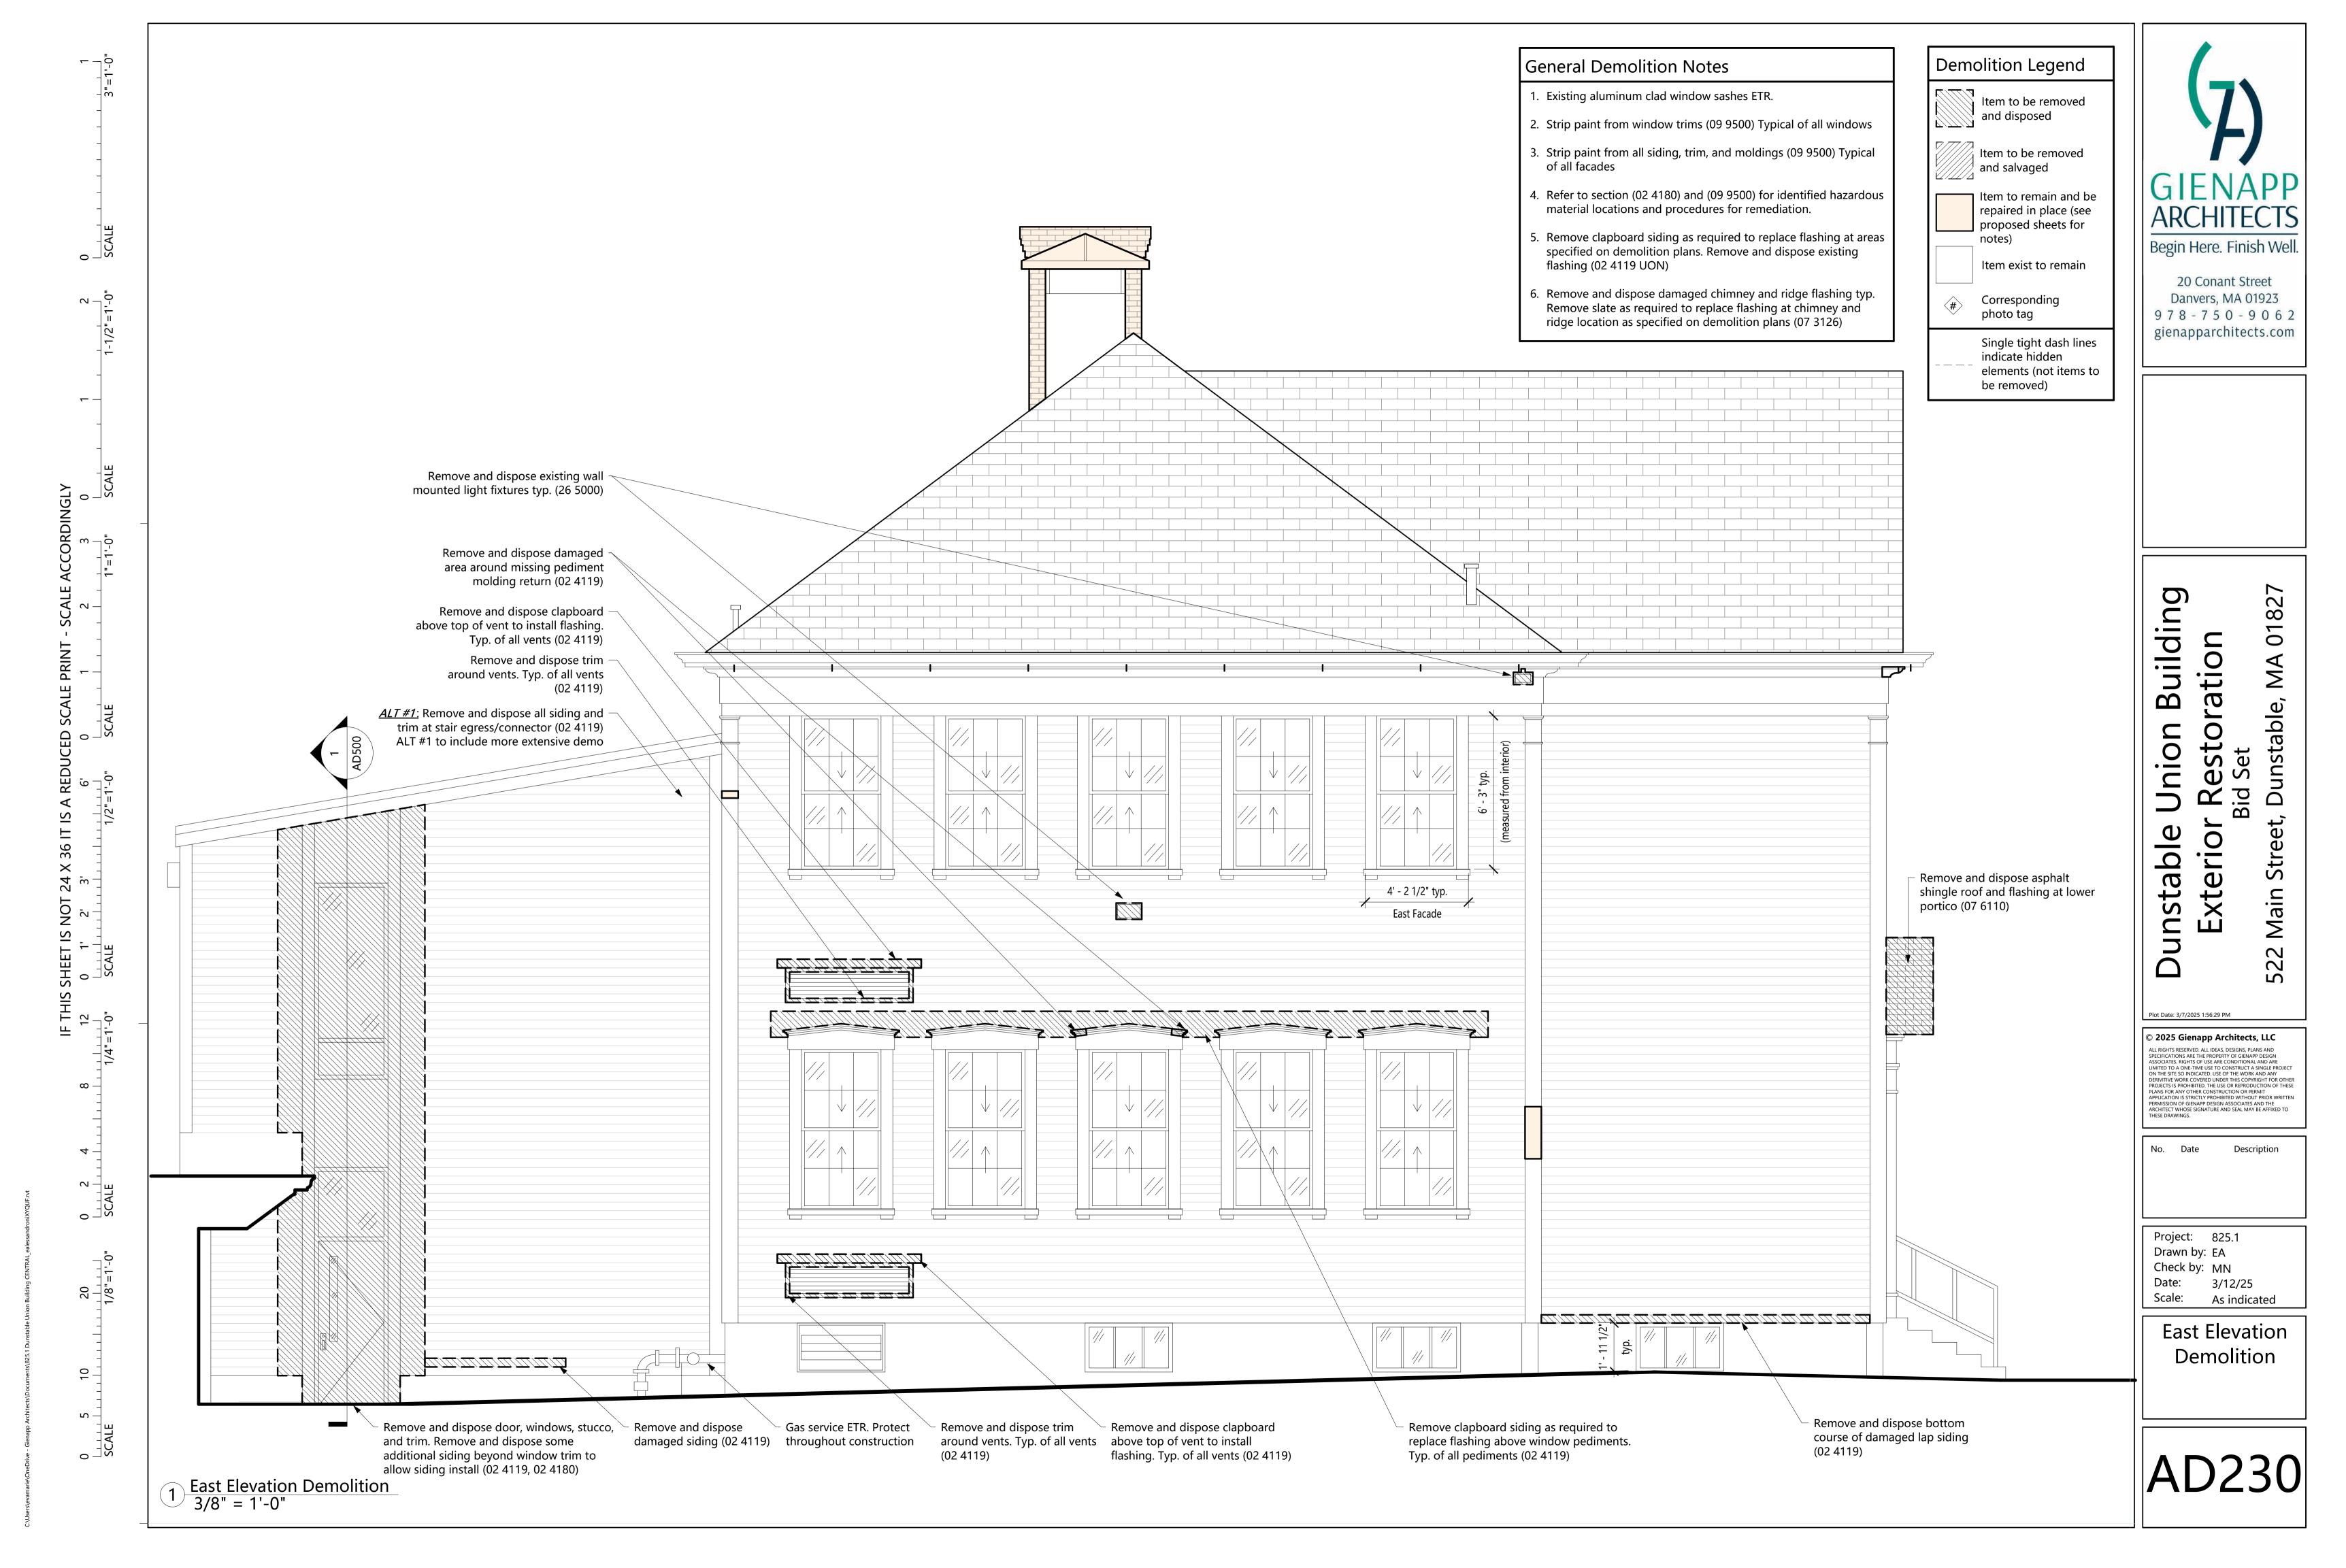Begin Here. Finish Well

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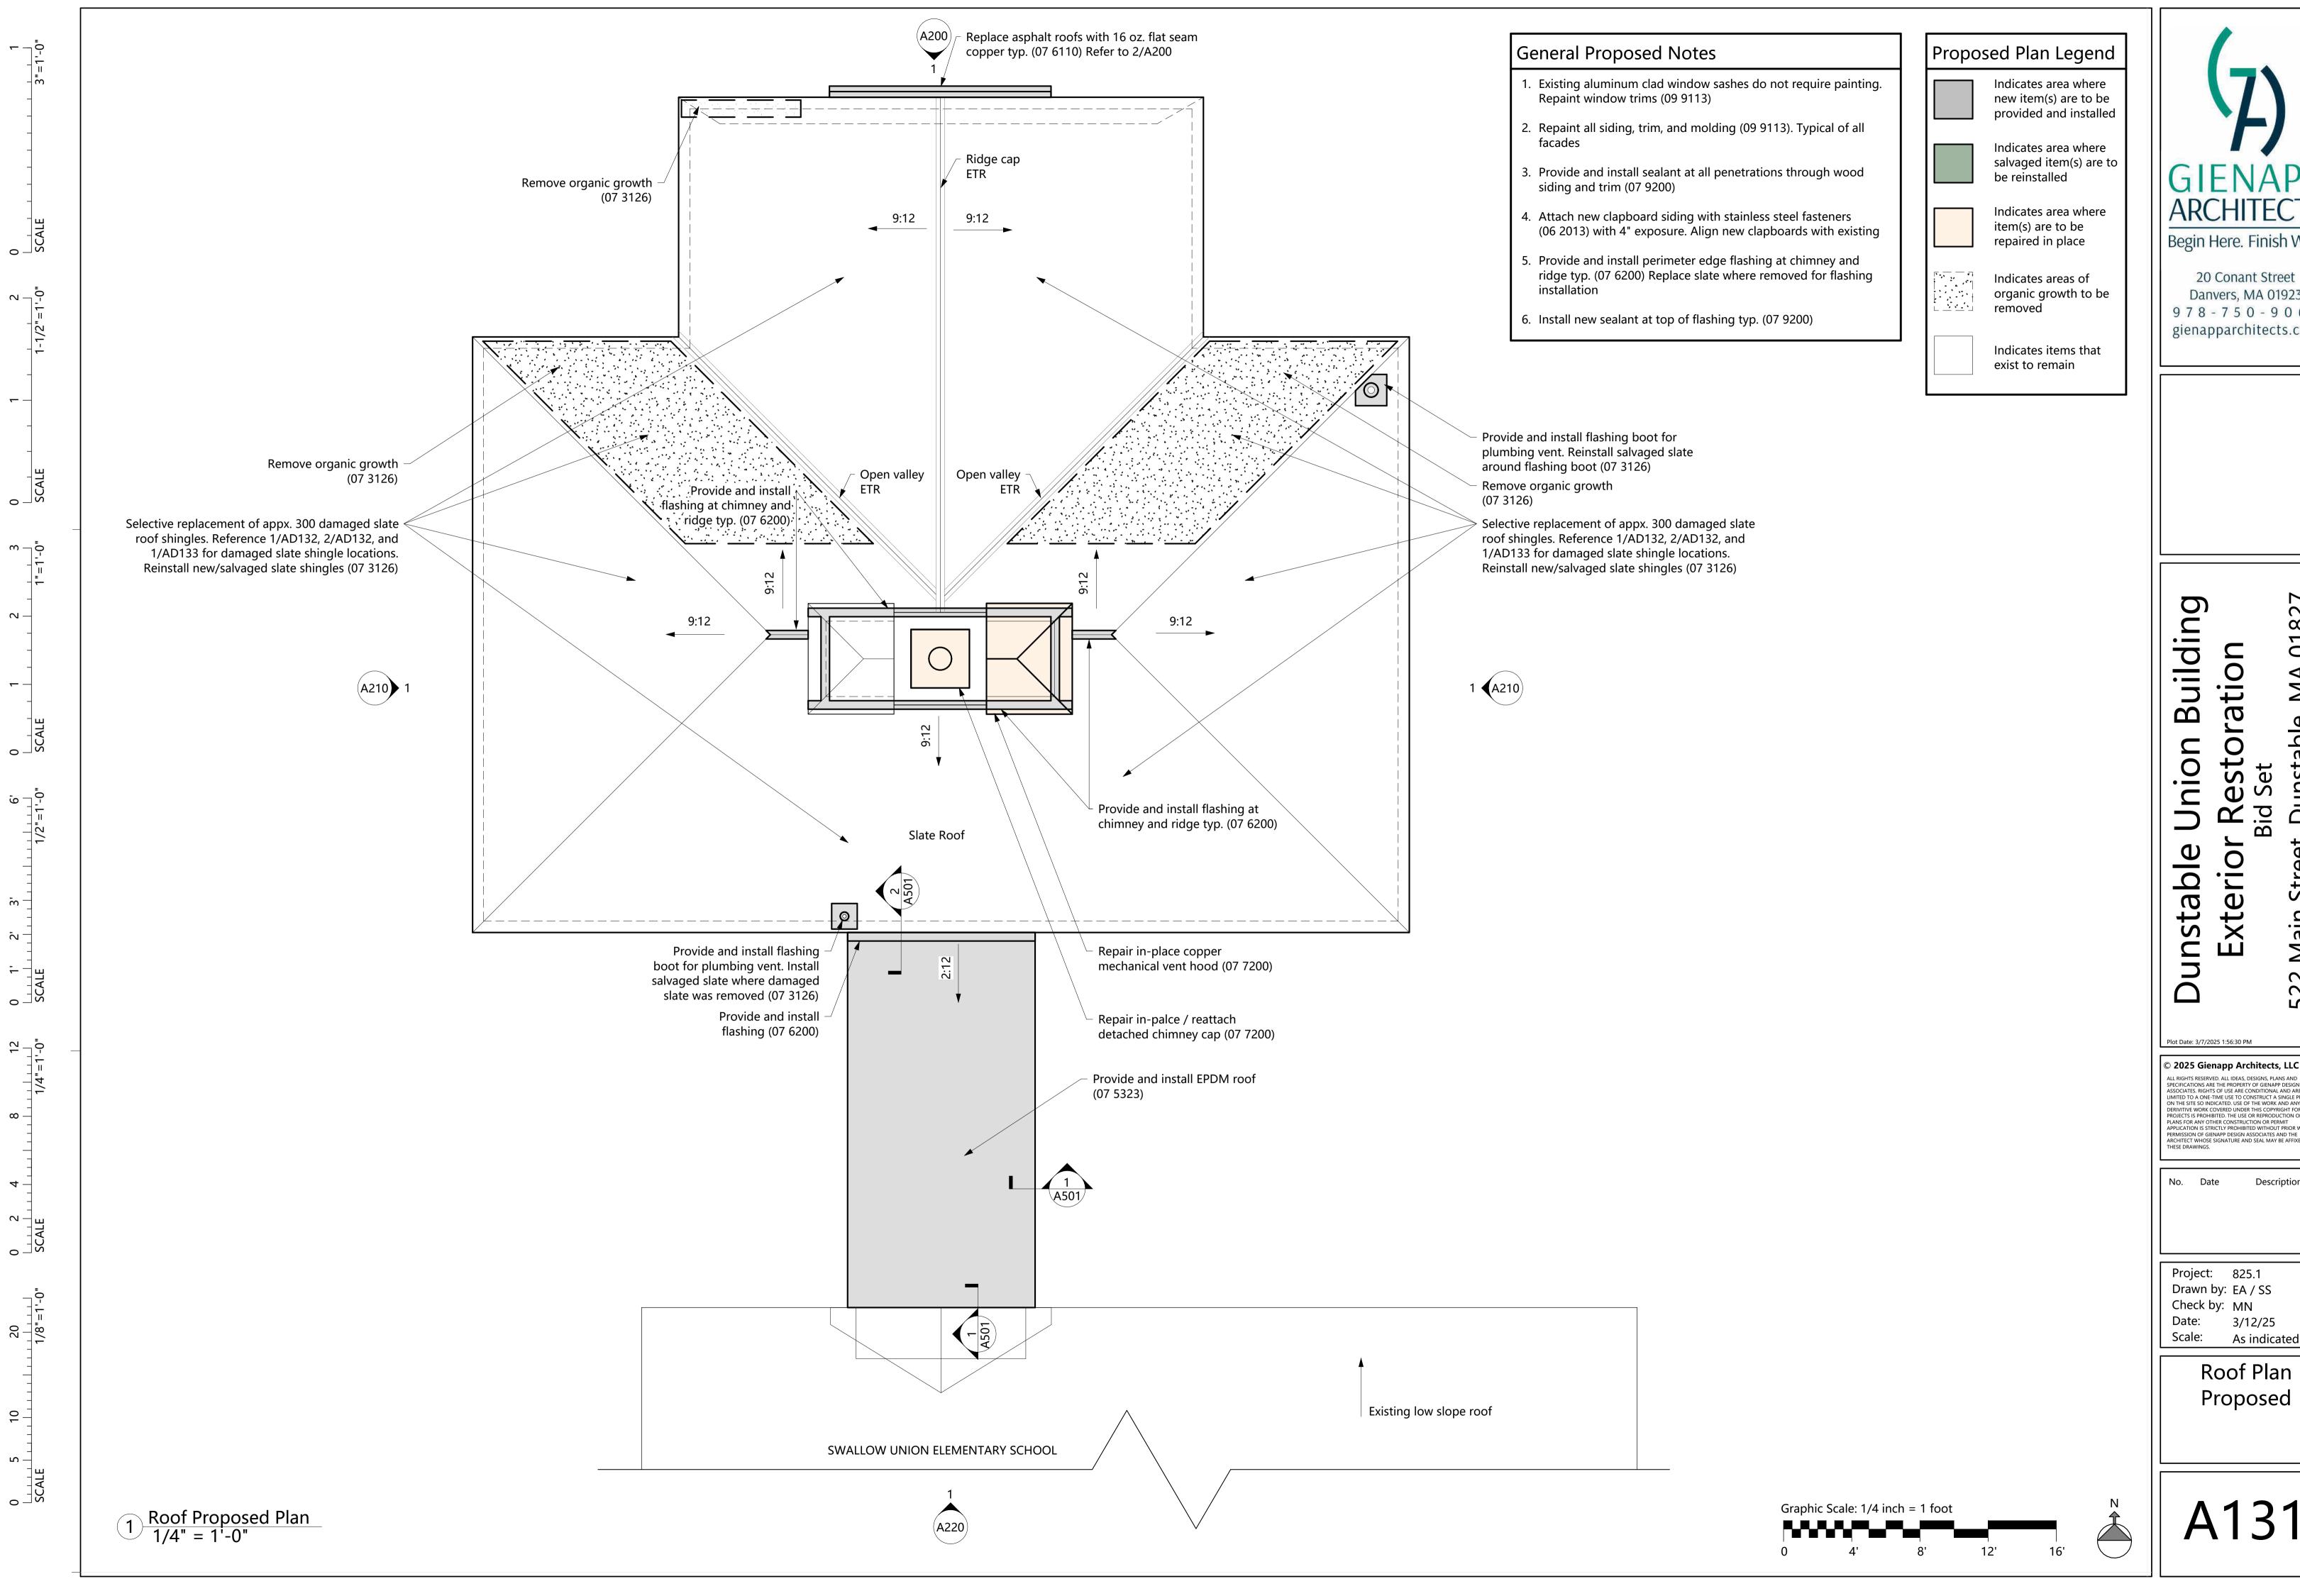
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. Date Description

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Check by: MN
Date: 3/12/25
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Egress Stair
Door & Window
Infill Details
Demolition



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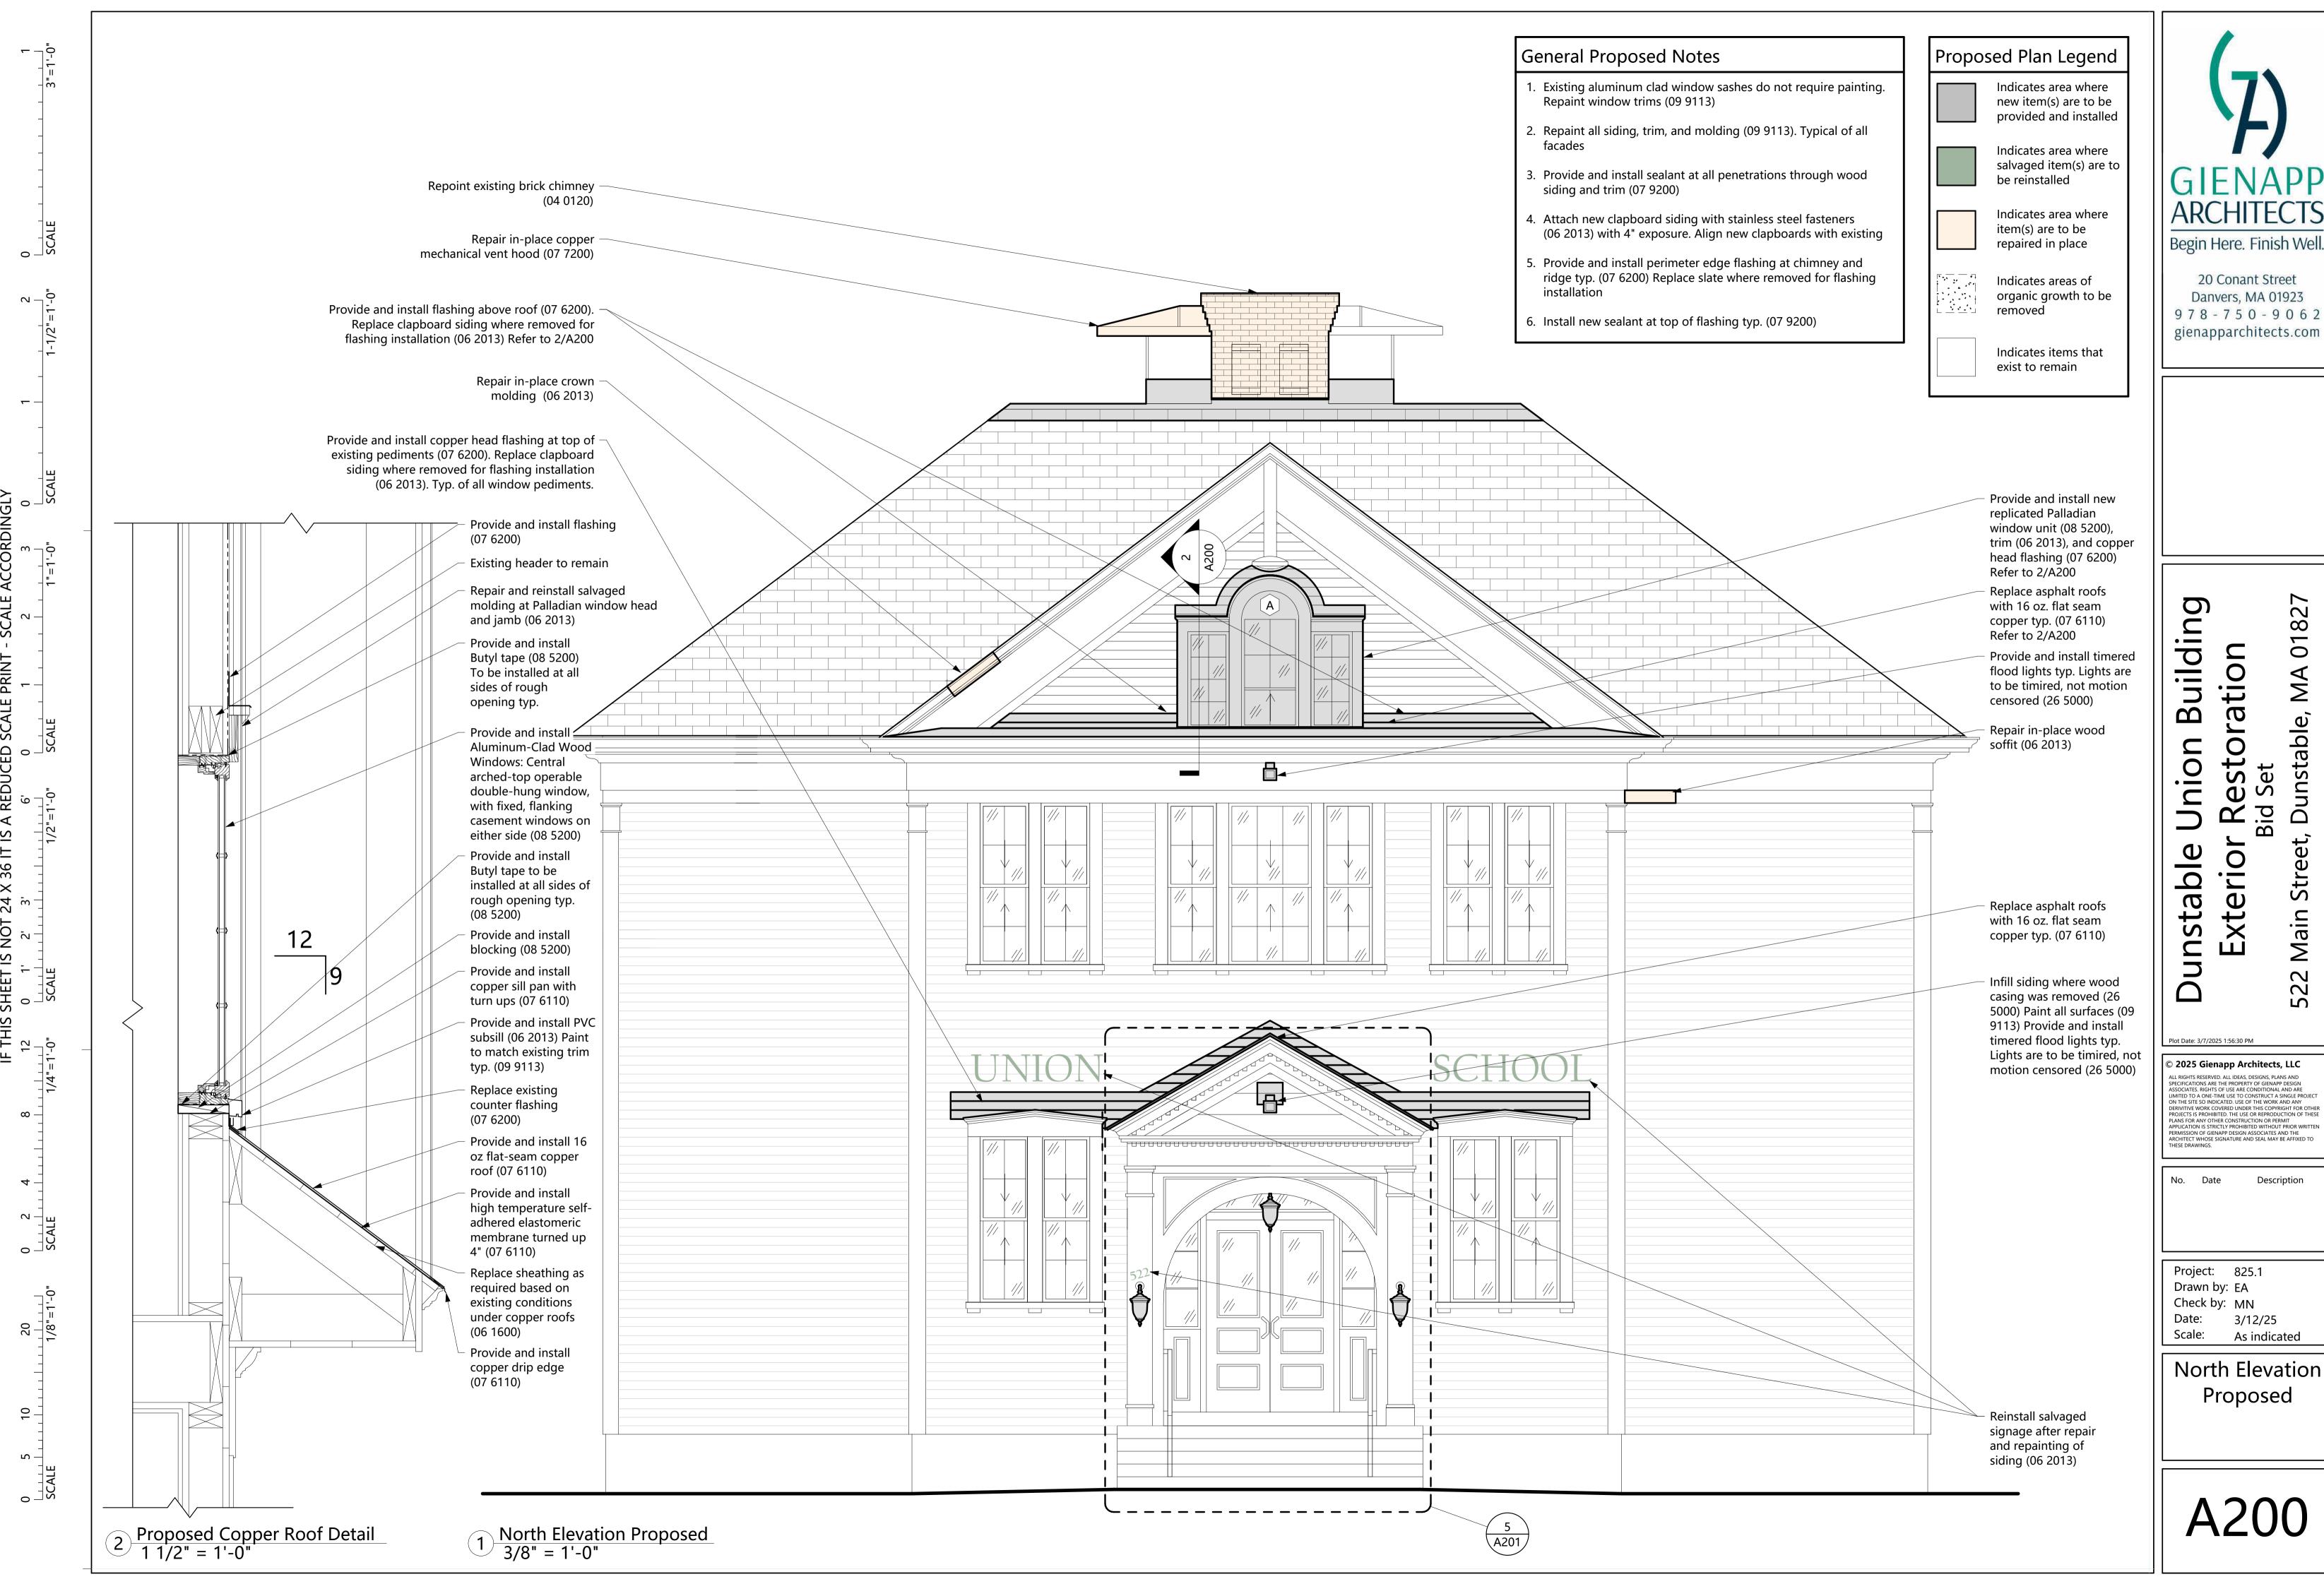
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Description

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> Roof Plan Proposed



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Street,


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Description

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North Elevation Proposed



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13 0 1' 2' 3'
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Existing Portico Railing

Connection

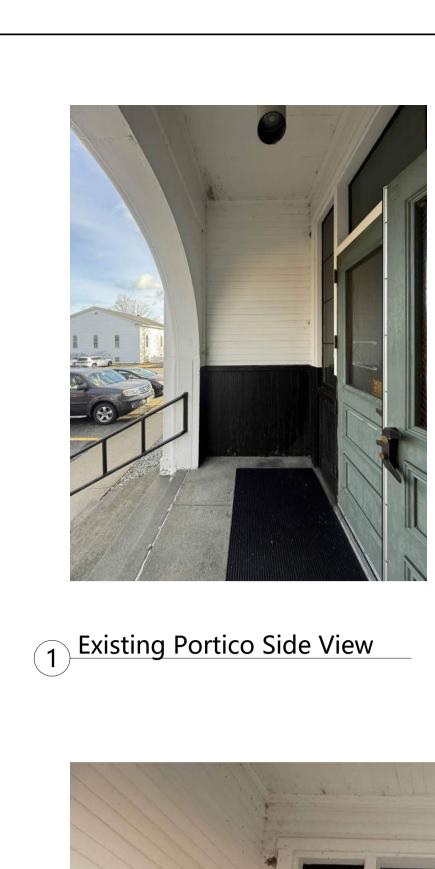


3 Existing Portico Front View



Existing Portico Bead board

Ceiling

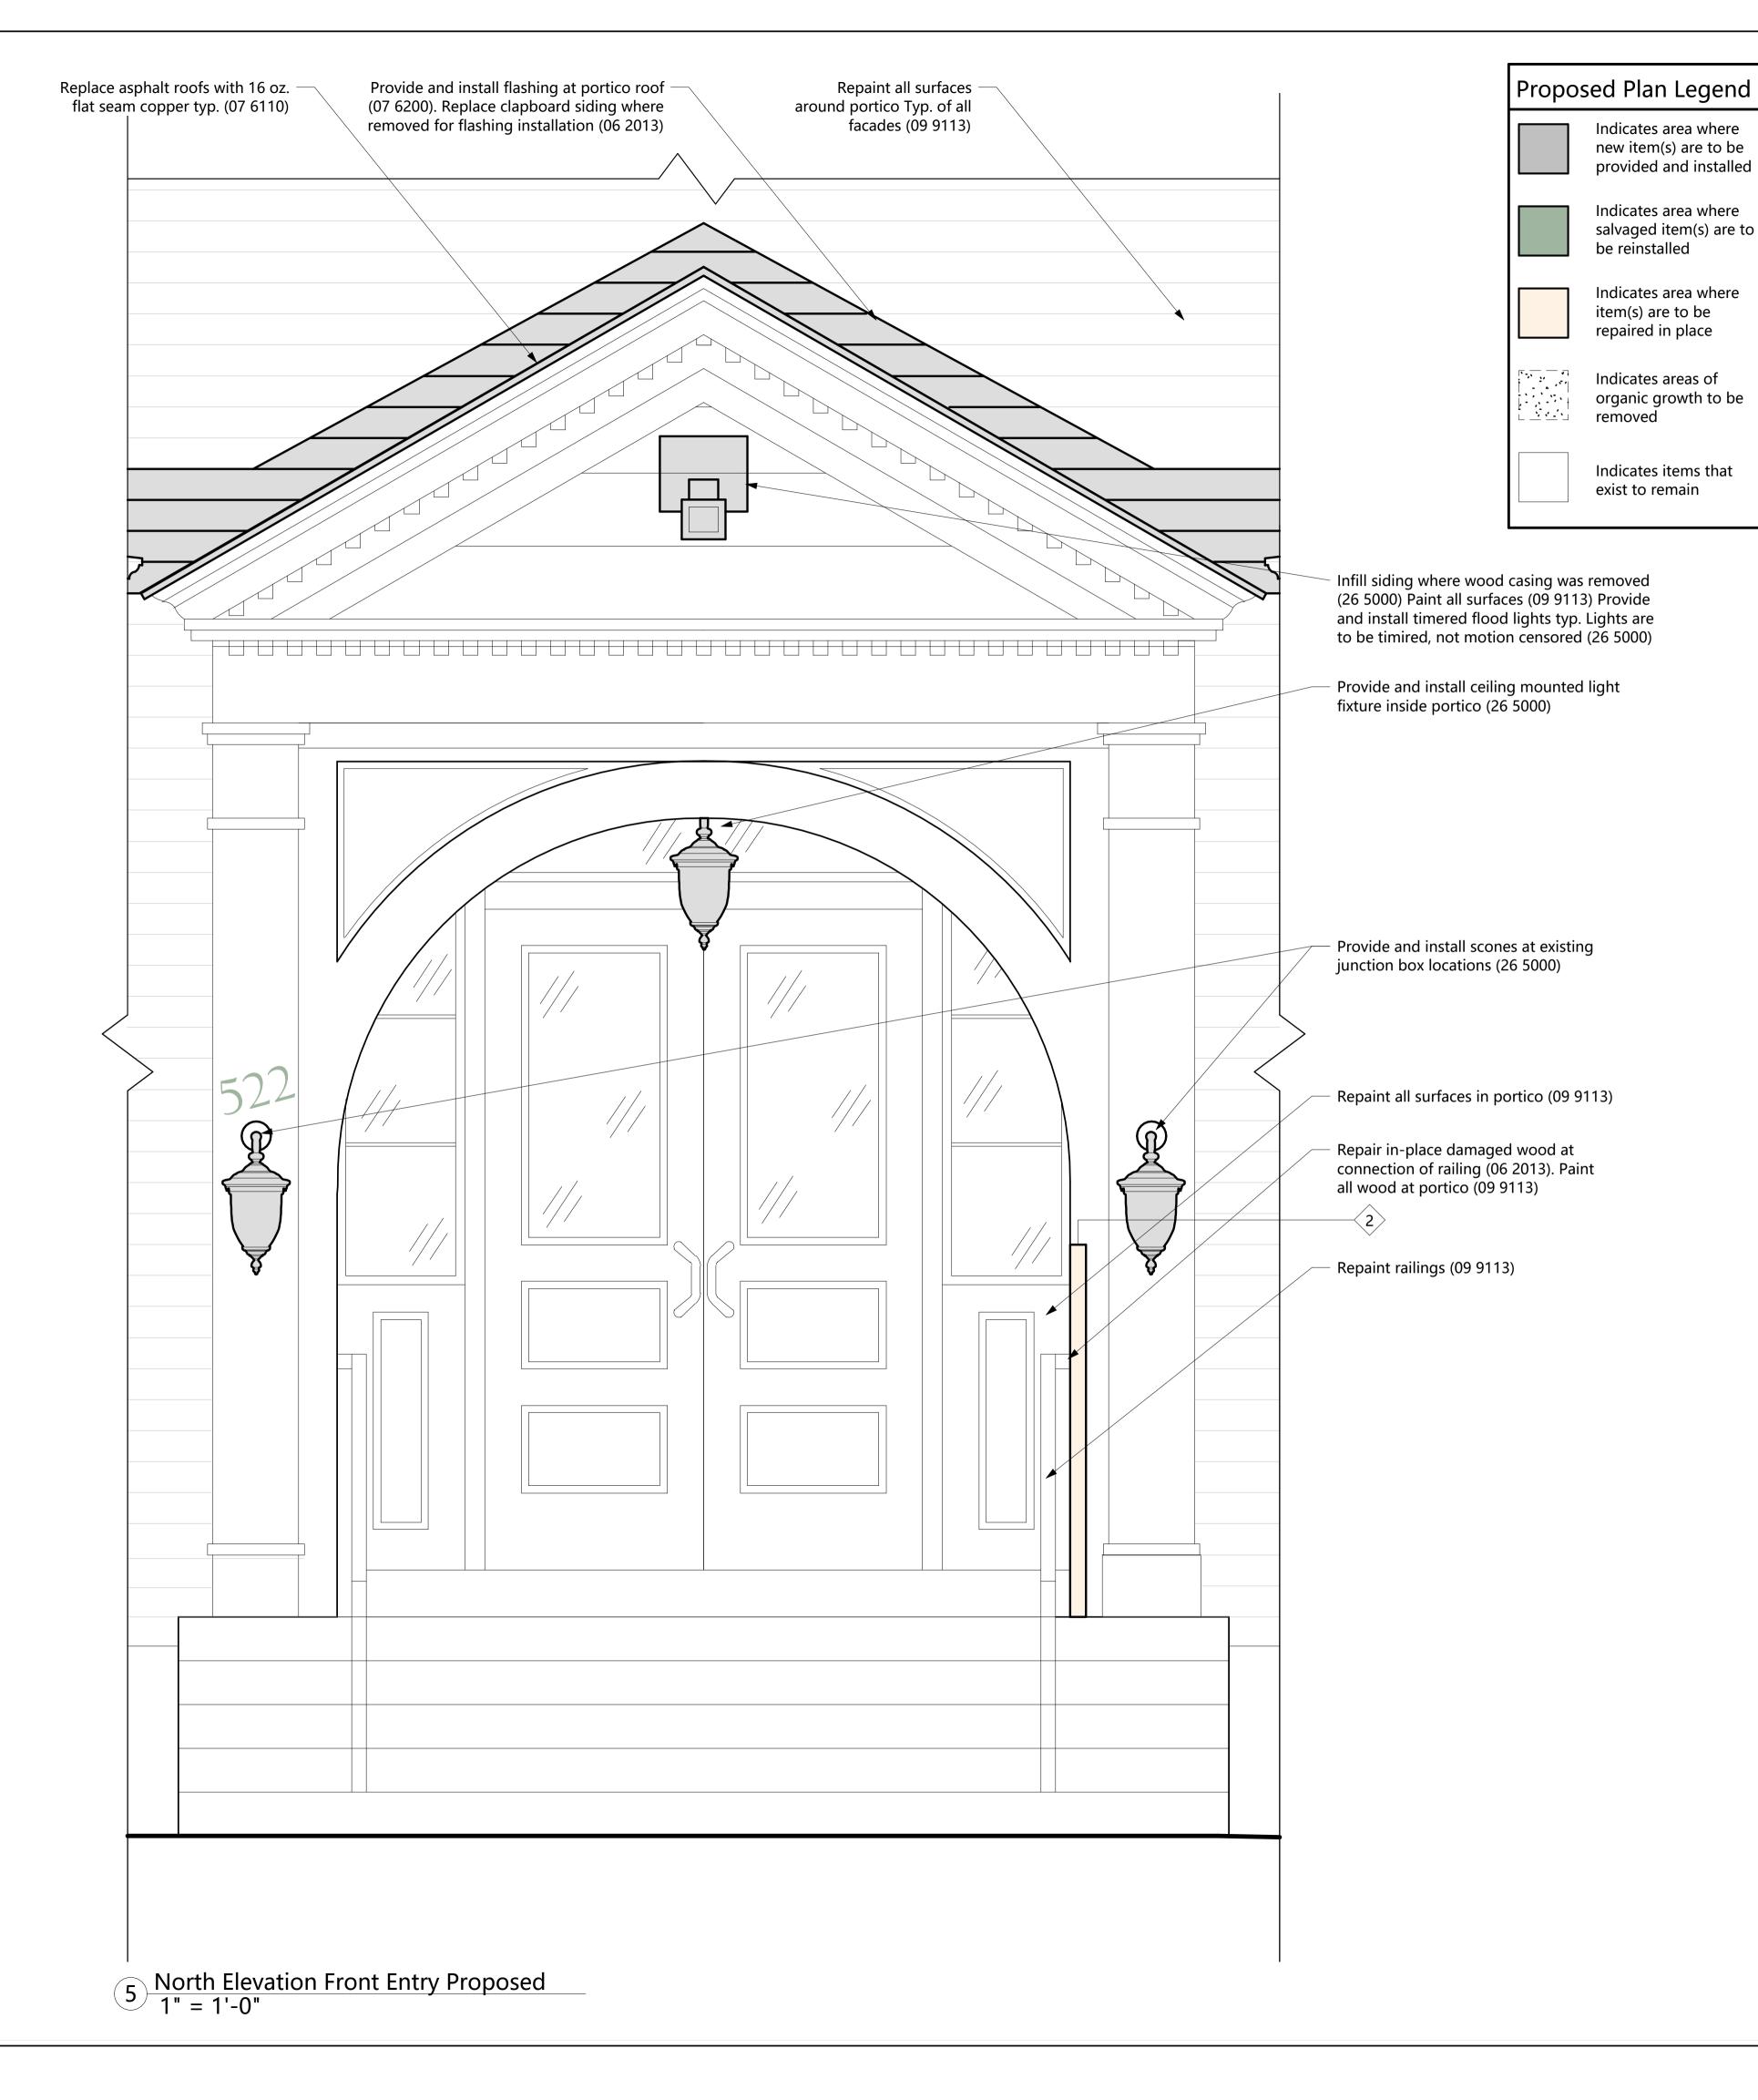

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## unstable Union Building Exterior Restoration Bid Set

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Street,

52

Description

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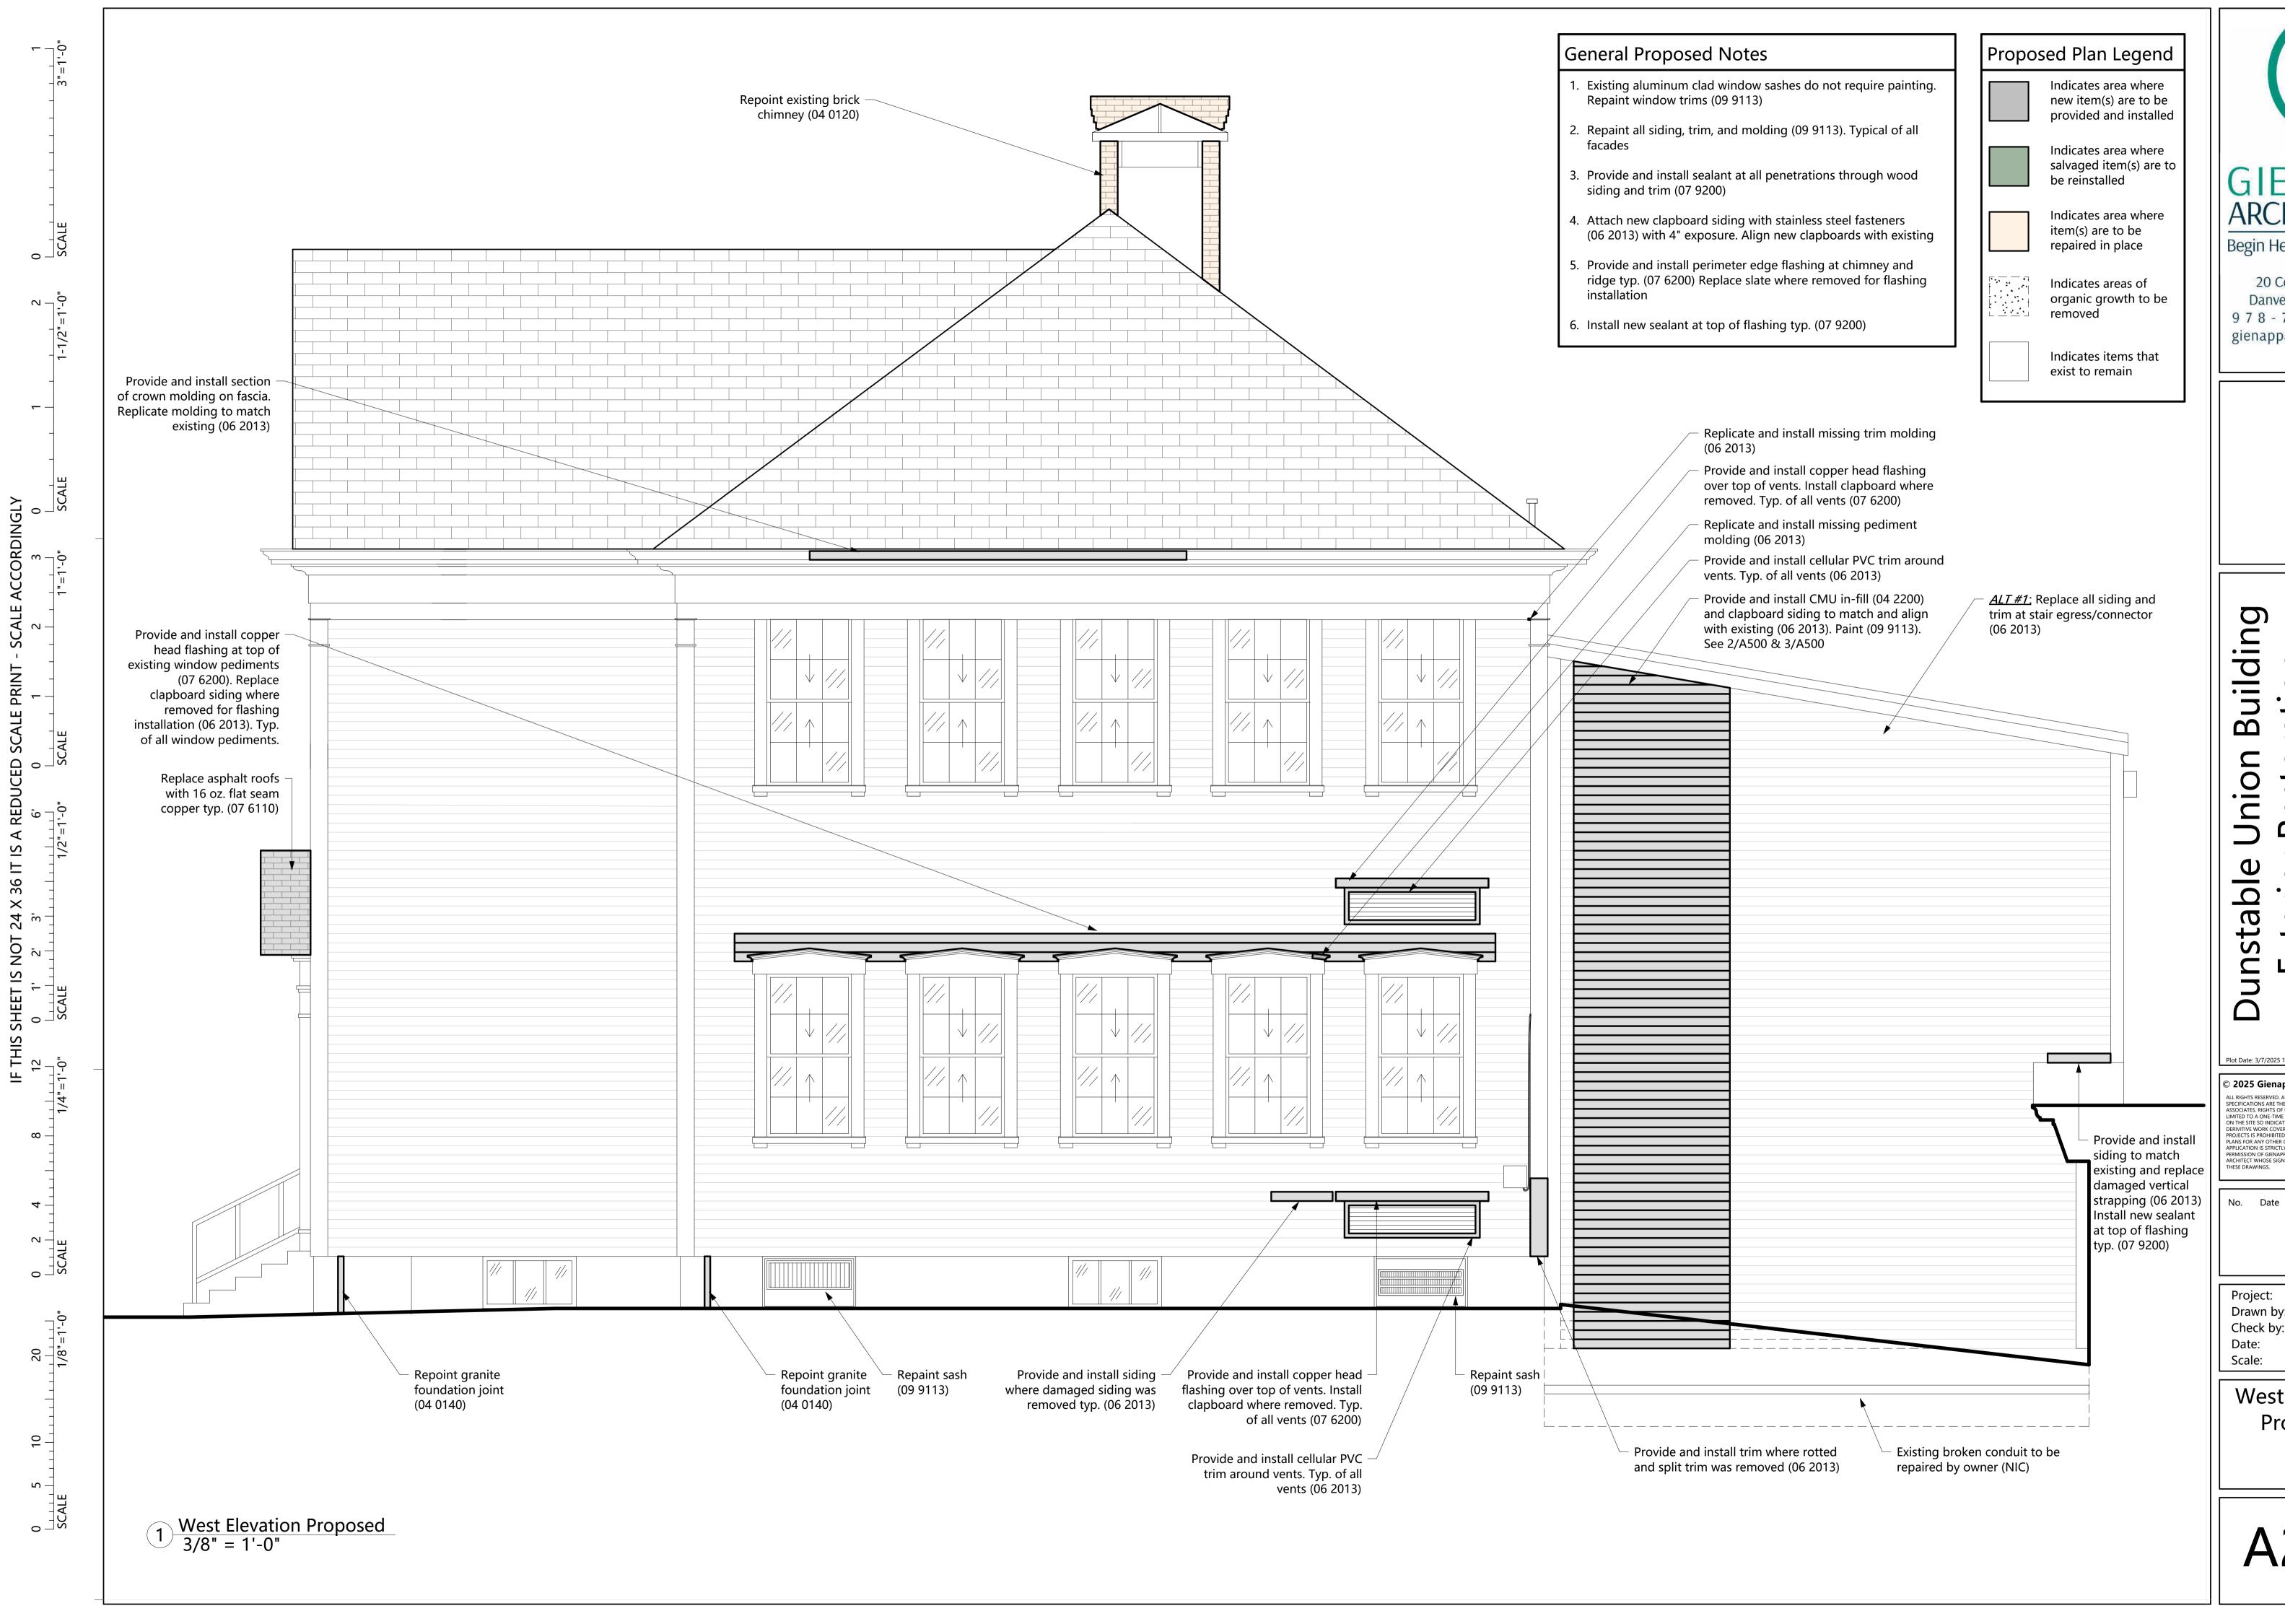
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North Elevation Front Entry Proposed

A201



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## ration **to** S

01827

Dunstable,

Street,

Main


<u>S</u> Exterior 522

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West Elevation Proposed



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Dunstable,

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Main

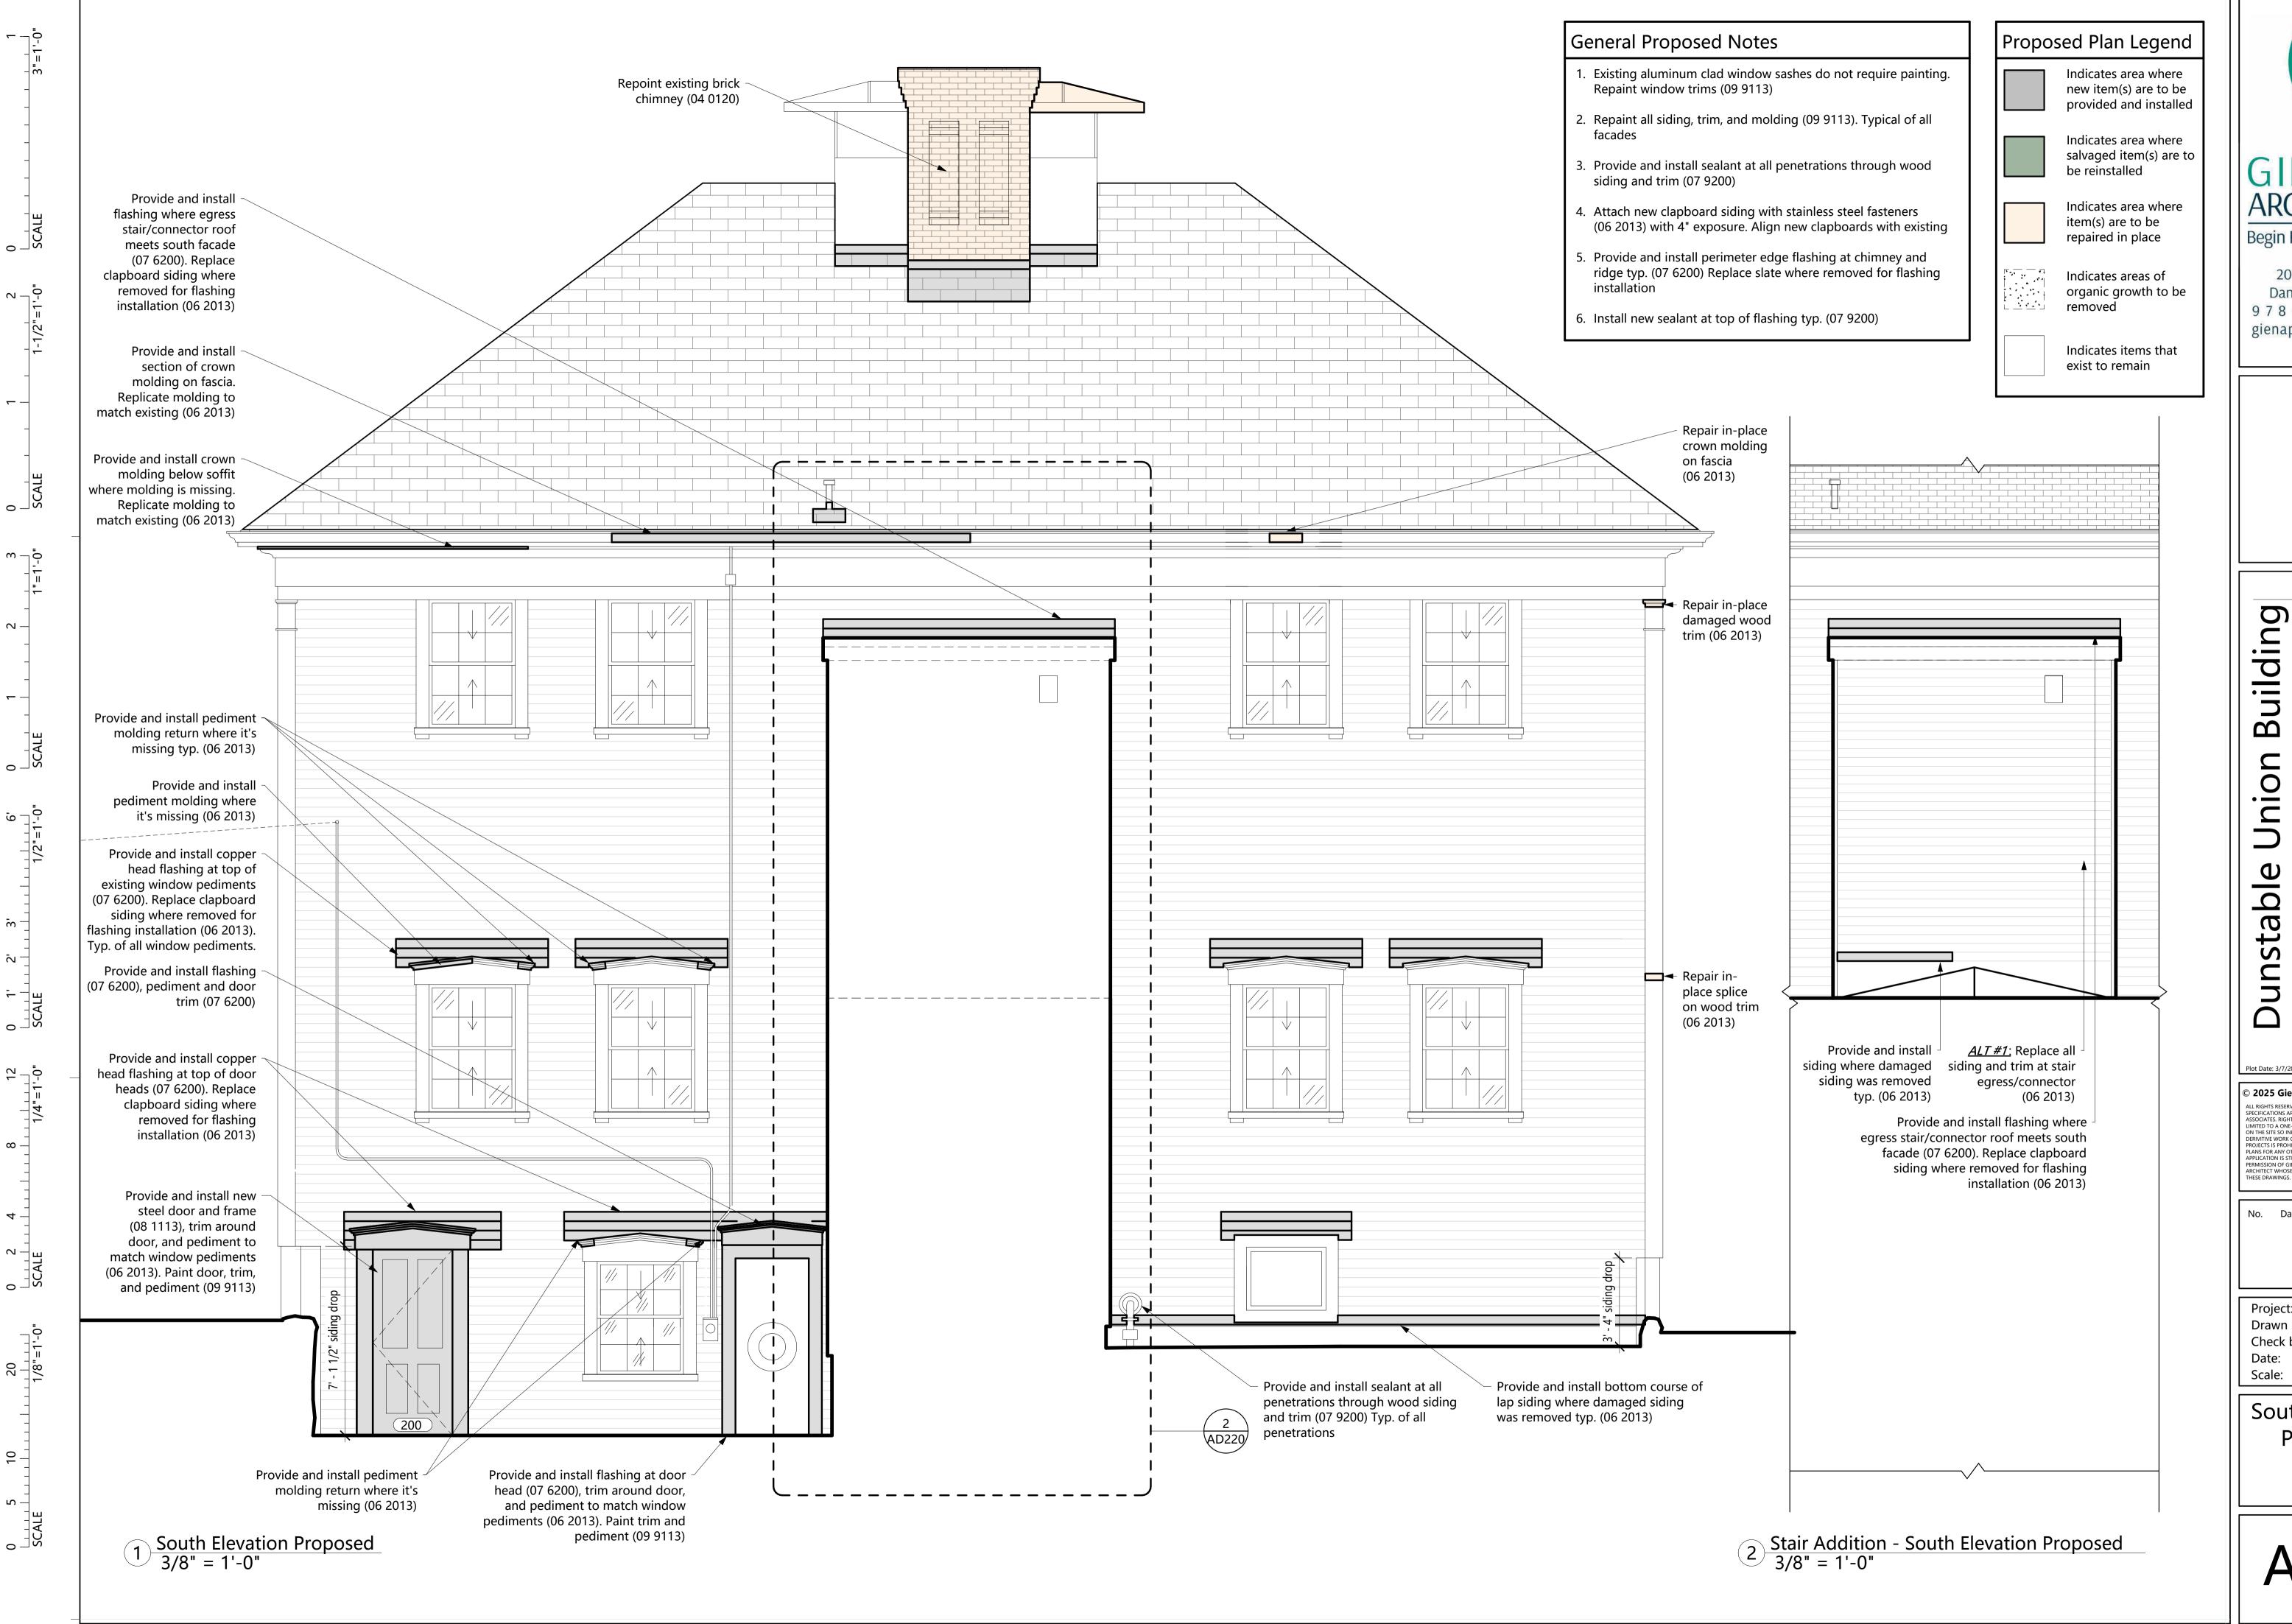52

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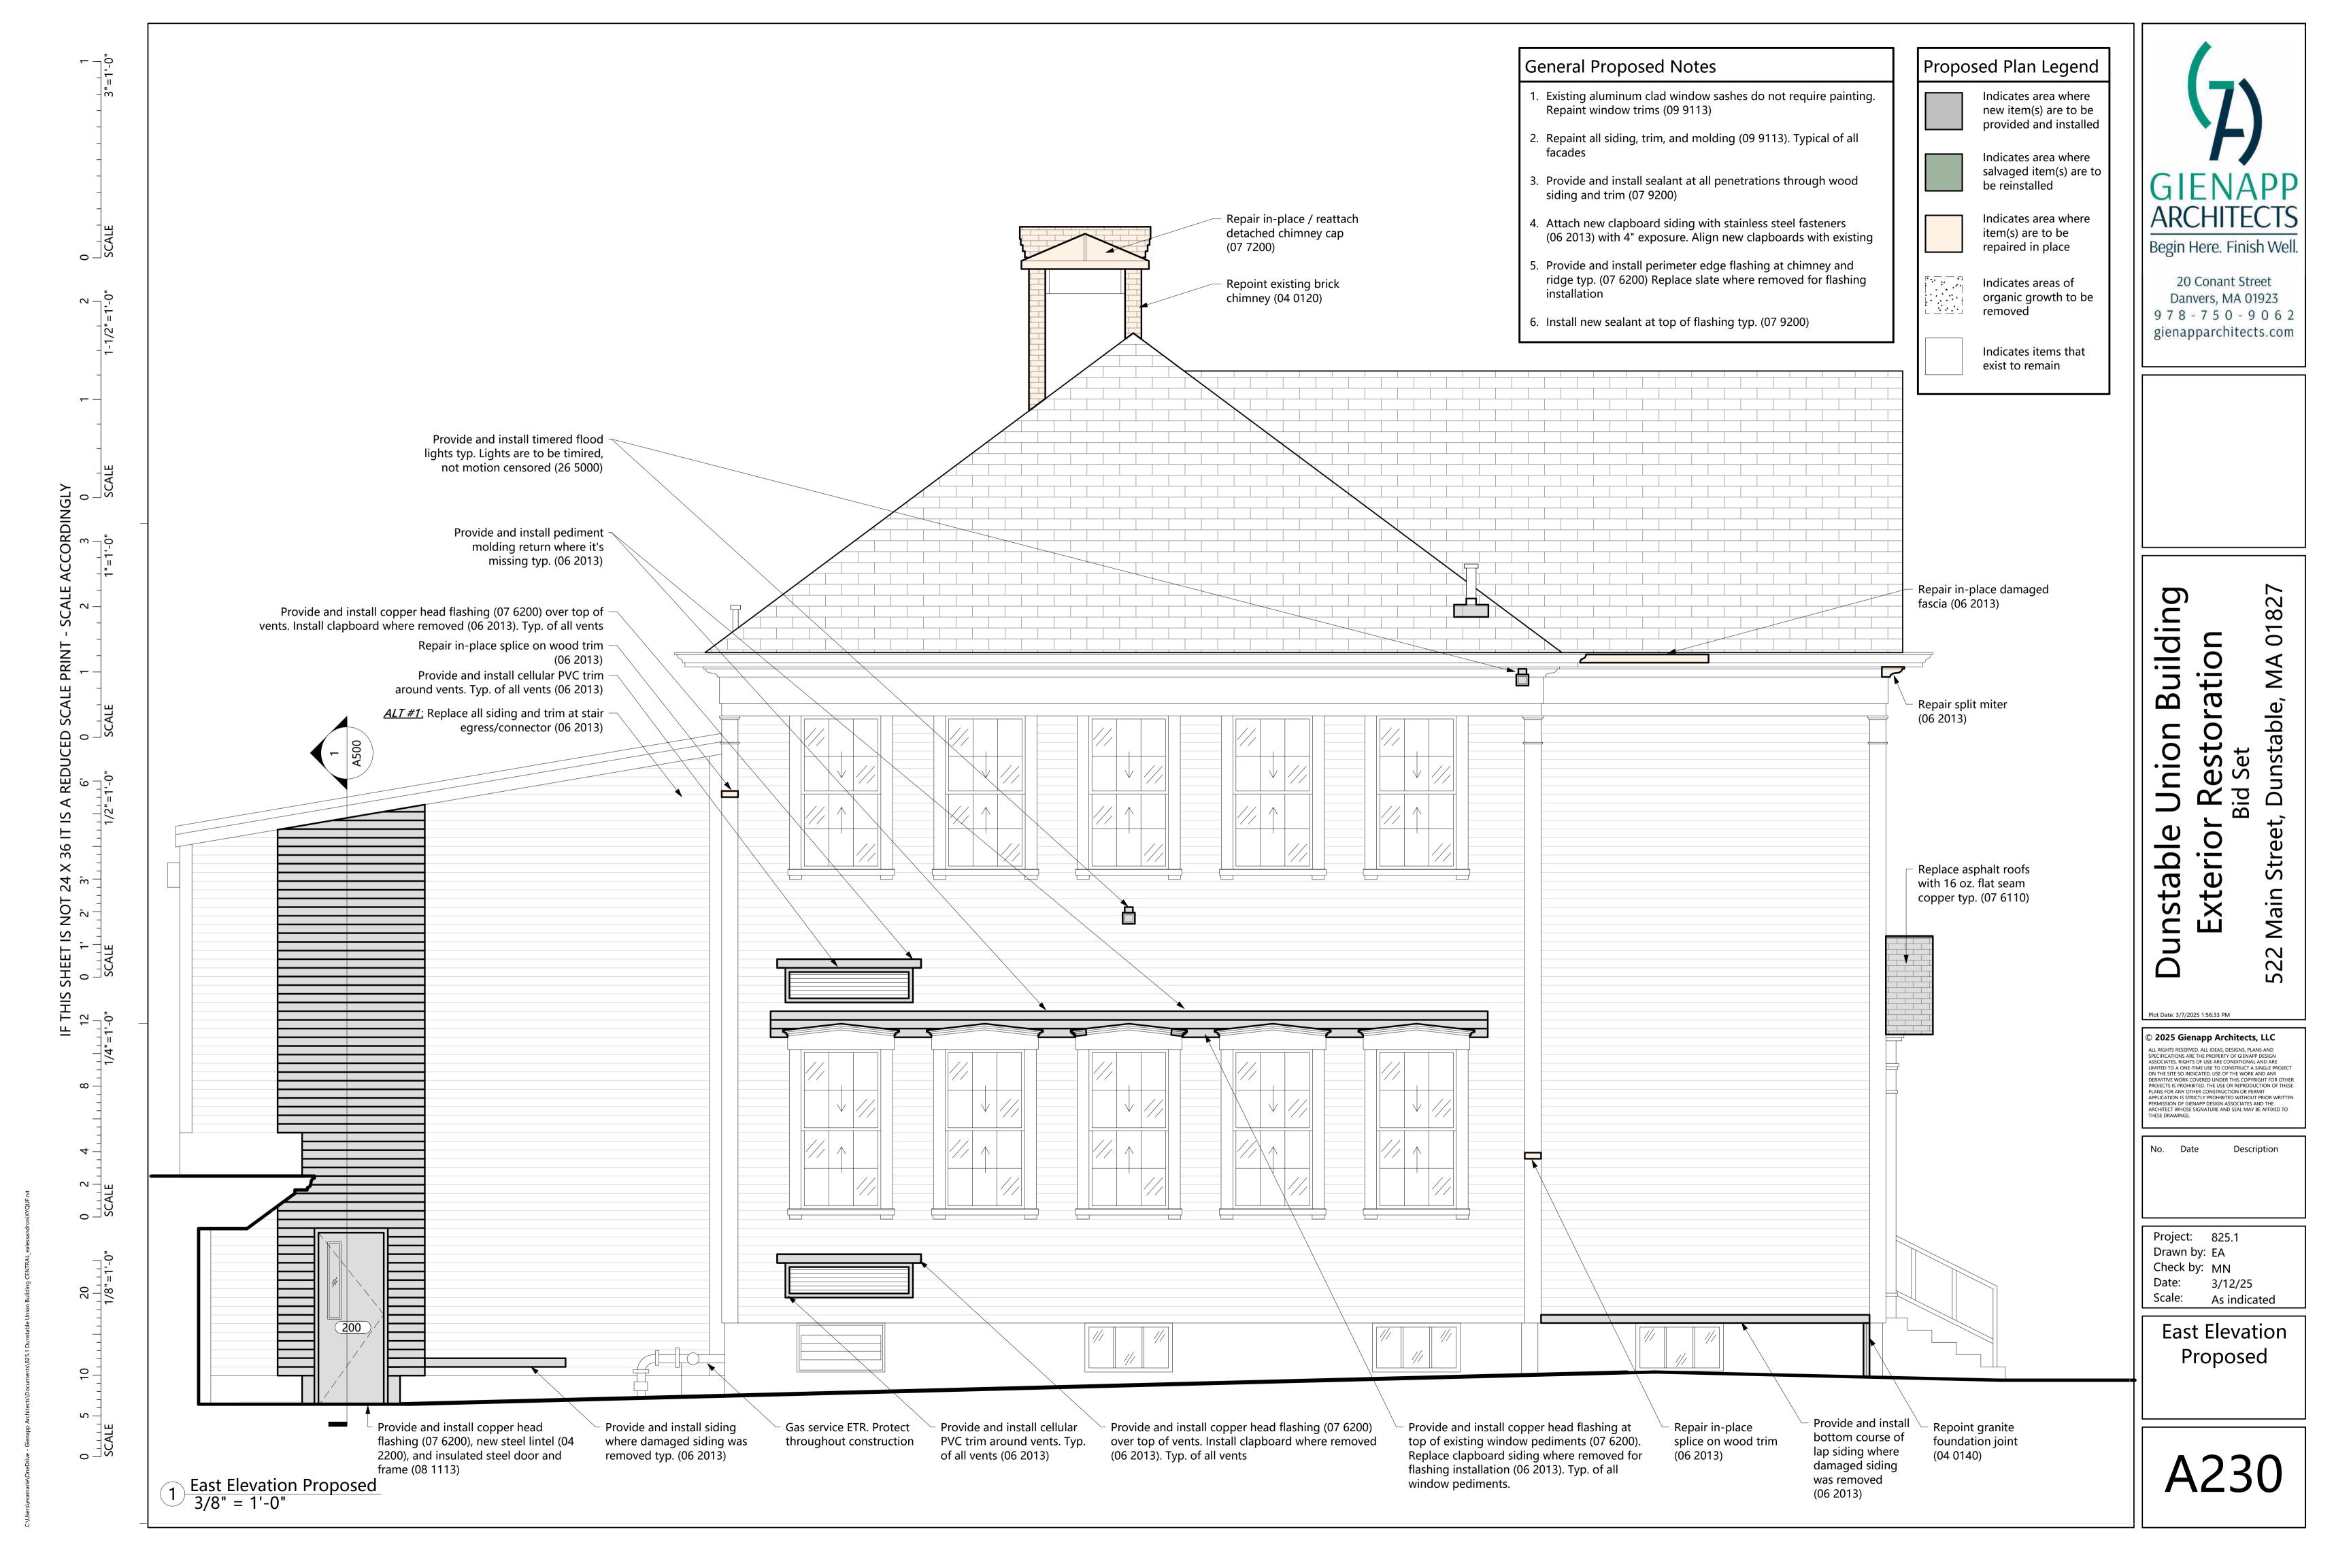
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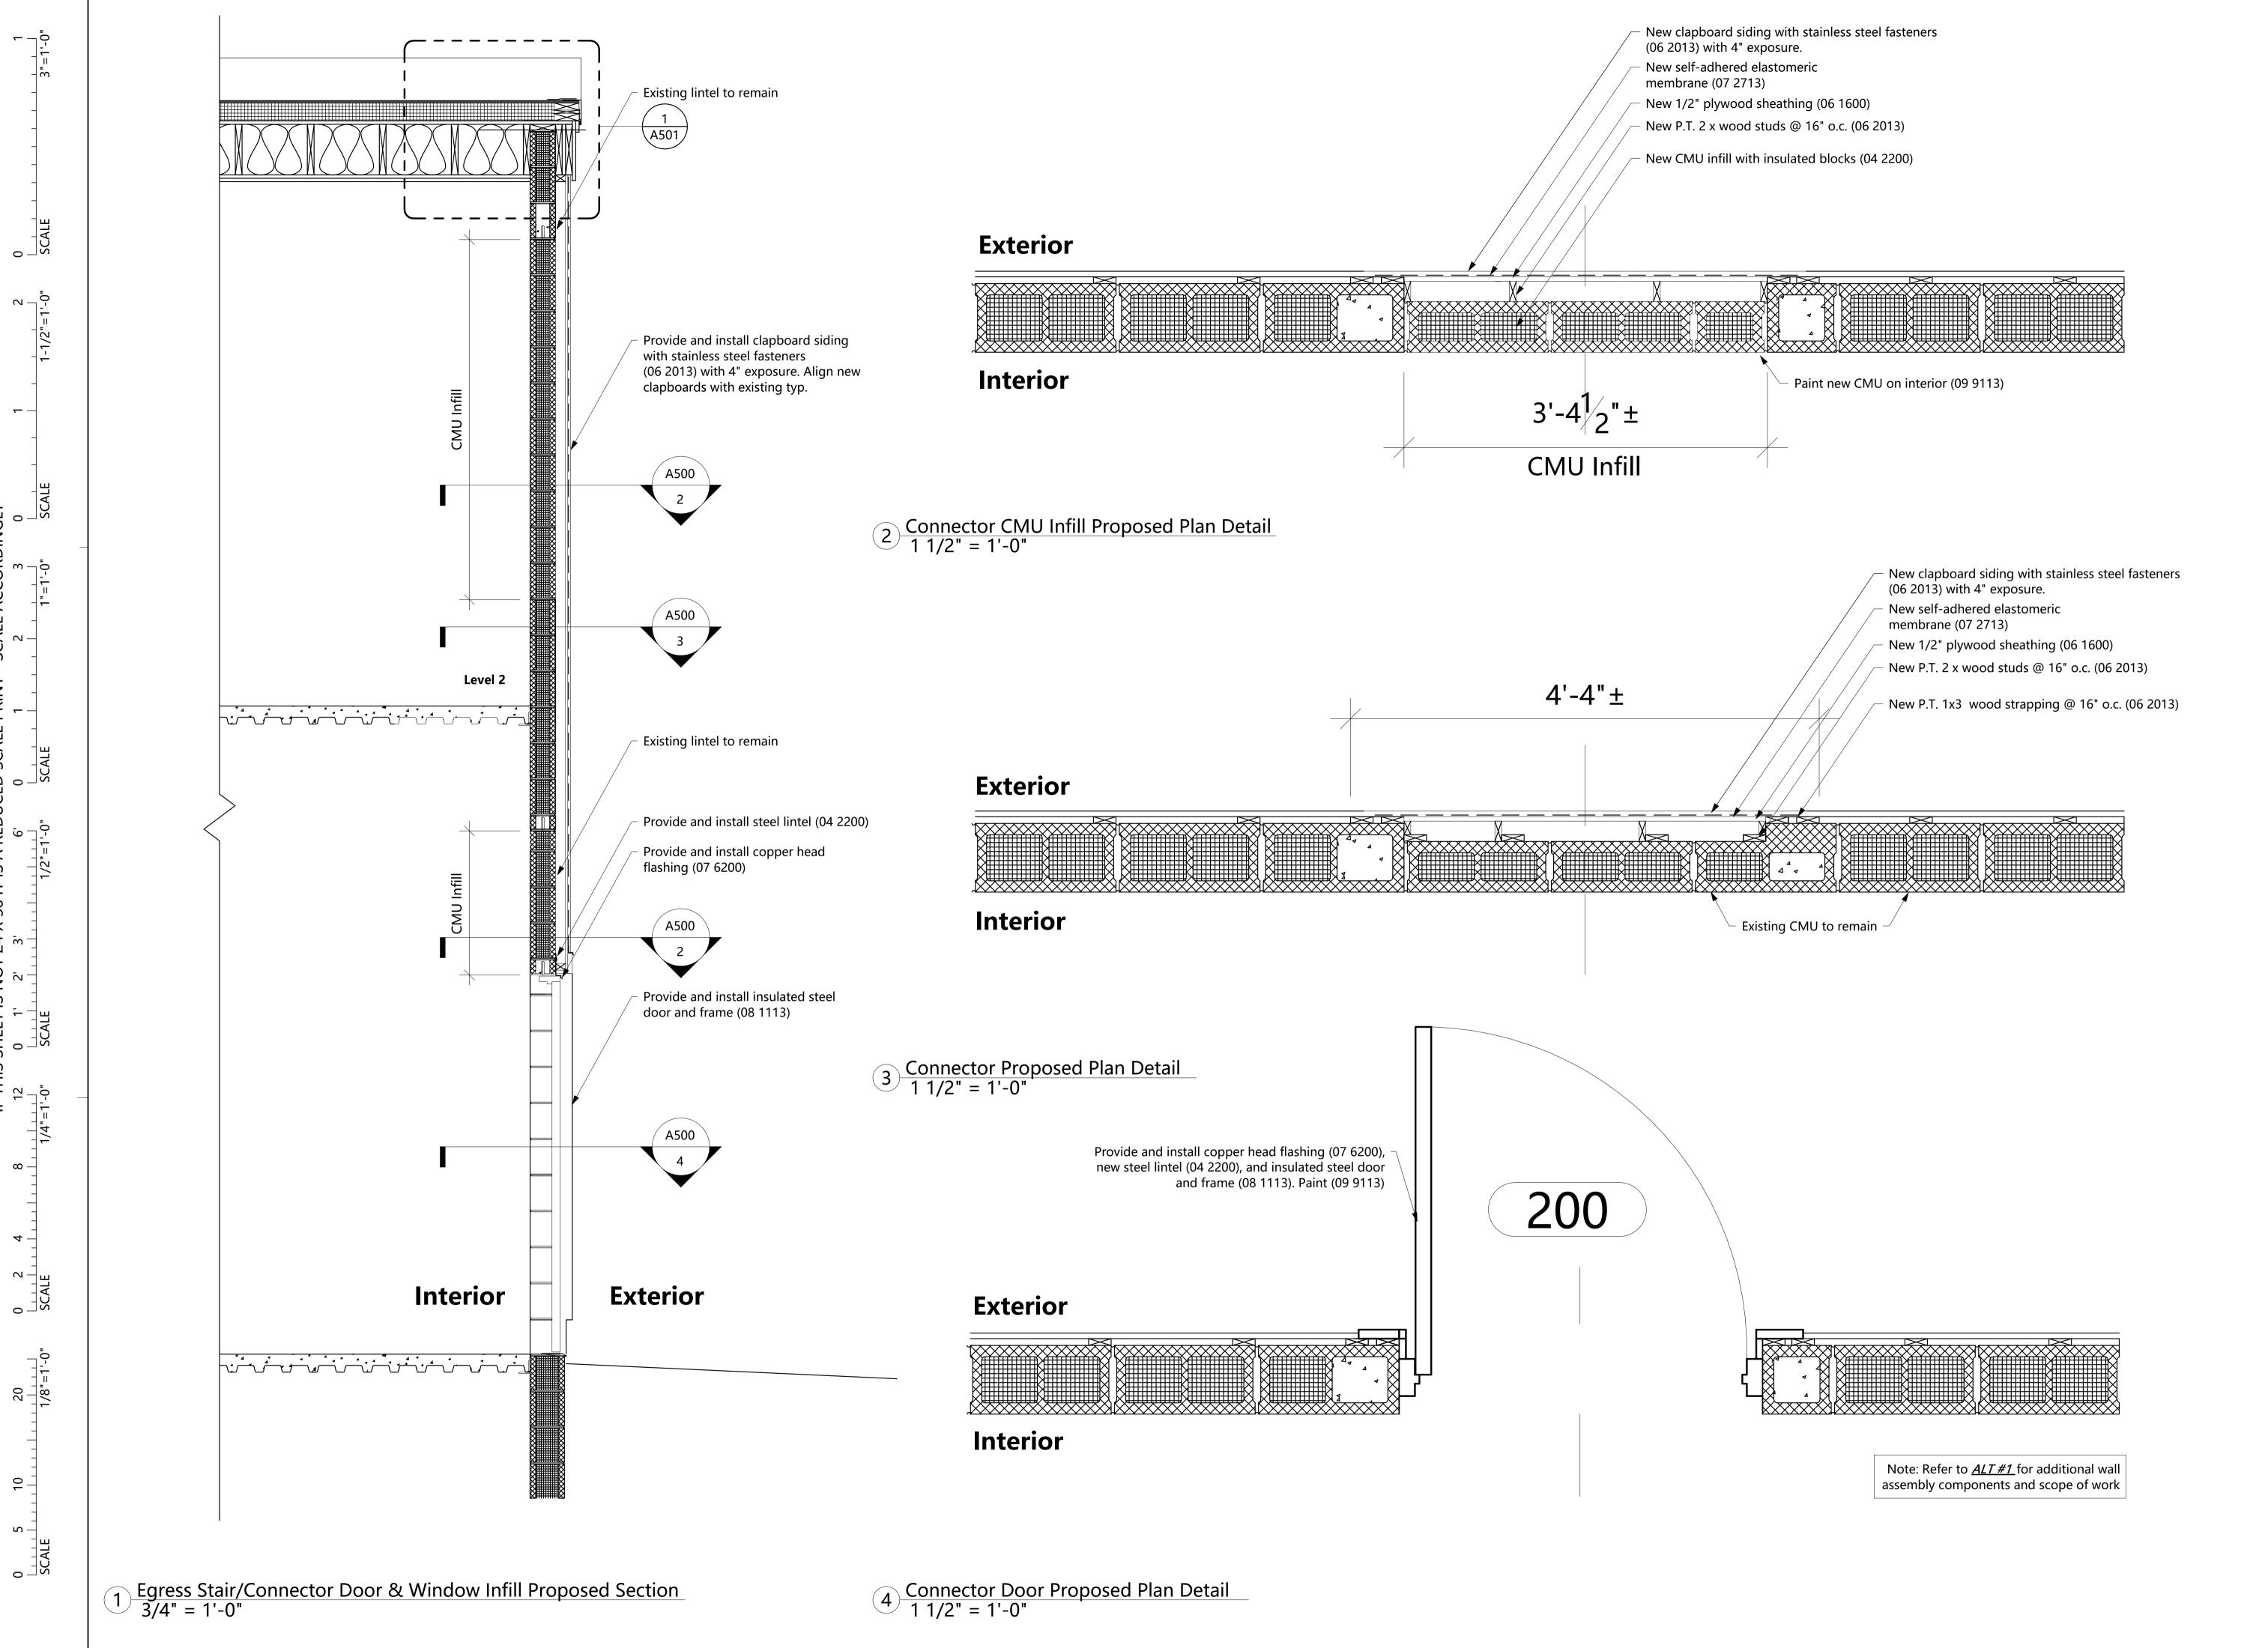
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South Elevation Proposed

A220





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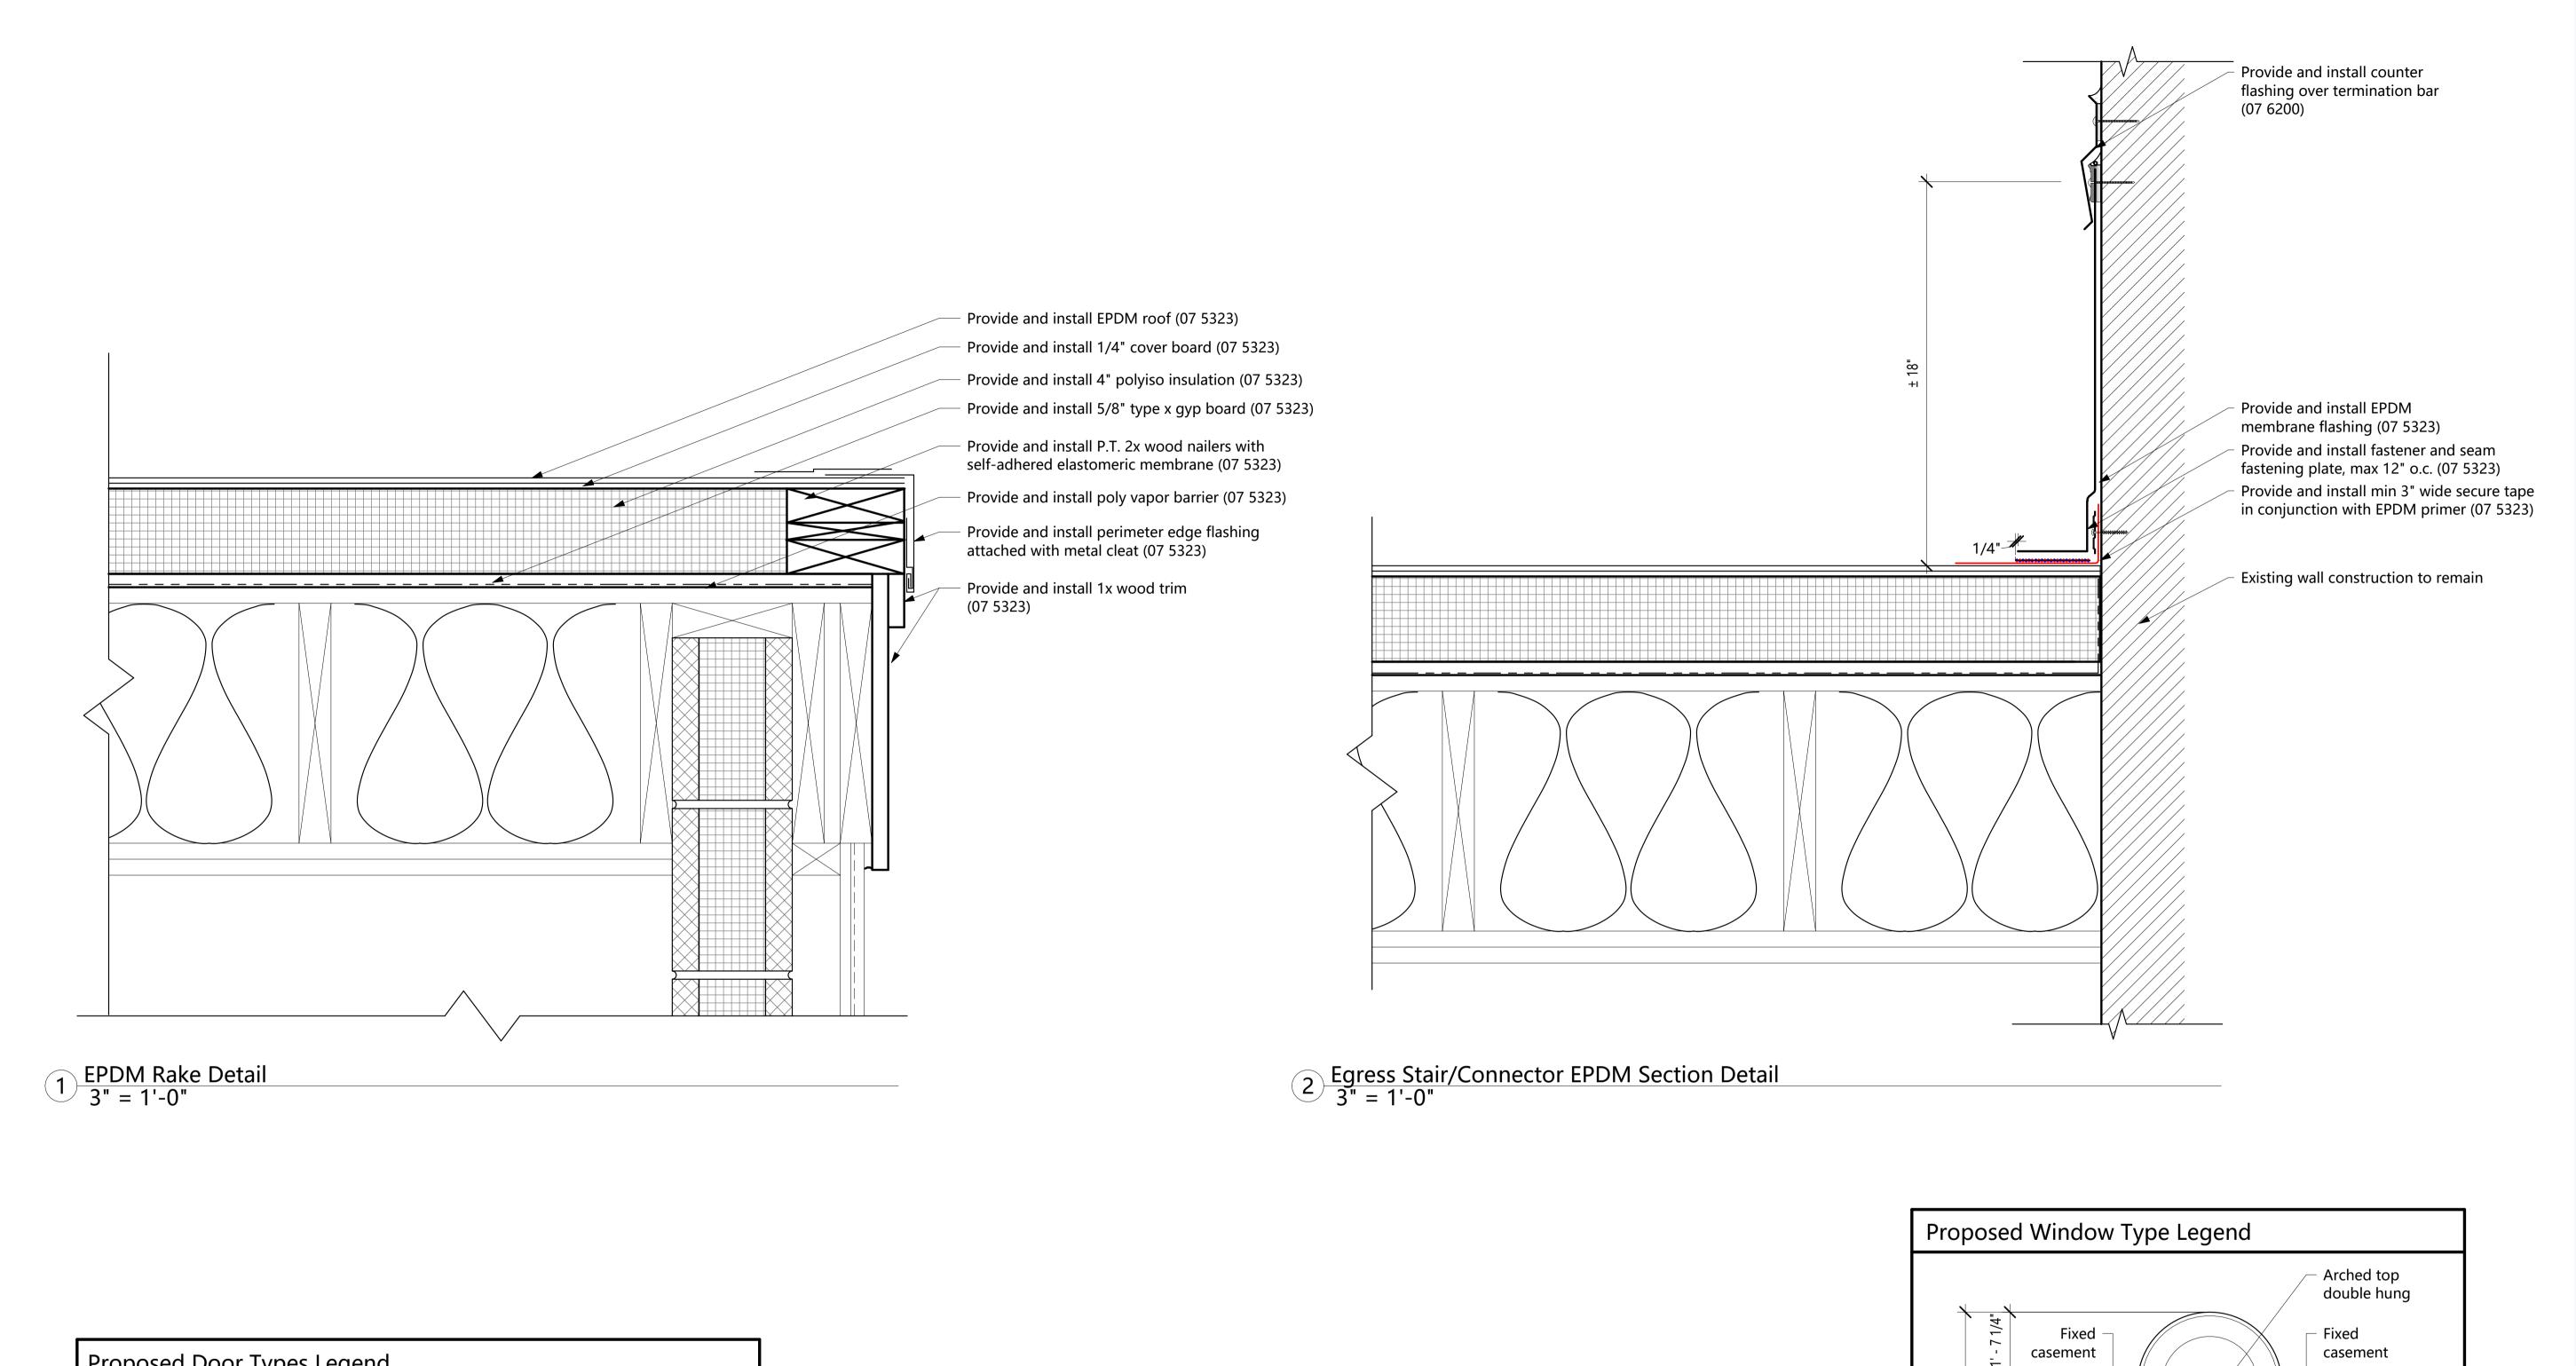
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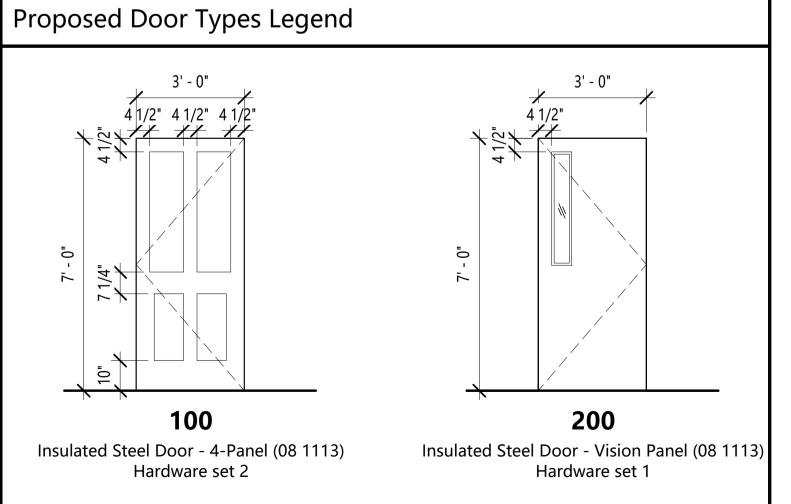
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Egress Stair
Door & Window
Infill Details

A500






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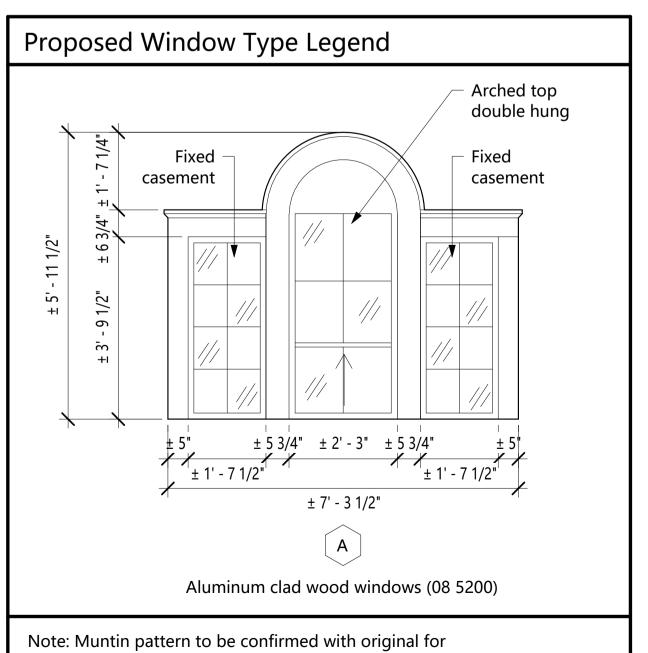
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Masonry Opening	Lintel Size		
Up to 3'-0"	L 3 1/2" X 3 1/2" X 5/16"		
3'-1" to 4'-6"	L 4" X 3 1/2" X 5/16" (4" leg vertical)		
4'-7" to 6'-0"	L 5" x 3 1/2" x 5/16" (5" leg vertical)		
6'-1" to 8'-0"	L 6" x 3 1/2" x 5/16" (6" leg vertical)		
<ol> <li>Provide metal lintels over all openings except where lintel blocks are provided and except where called for in the drawings.</li> <li>Provide one angle for each 4" of wall thickness. For 6" walls,</li> </ol>			

- Provide one angle for each 4" of wall thickness. For 6" walls, provide tee or built-up section with properties equal to or greater than 1 1/2 times the angle properties for a 4" wall thickness.
- 3. Provide 8" of bearing each end of all lintels.4. Lintels shall be galvanized.

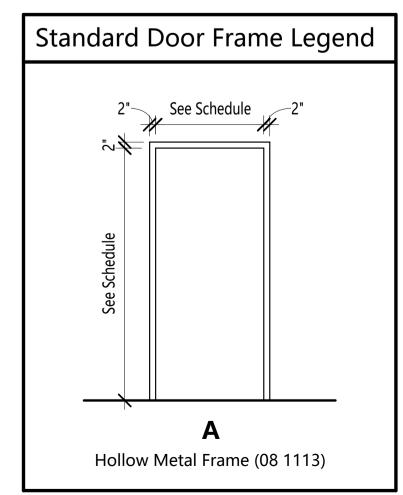

historic accuracy

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Proposed
Details &
Schedules

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